
# 05.03 - STRUCTURE INDEX OF DRAWINGS

DRAWING NUMBER	DRAWING TITLE	DRAWING NUMBER	DRAWING TITLE	DRAWING NUMBER	DRAWING TITLE
S-01	INDEX OF DRAWINGS	S-26	ARCH RIB REPAIRS (2 OF 2)		
S-02	GENERAL PLAN	S-27	FLOORBEAM REPAIRS		
S-03	TYPICAL SECTION AND PROFILE	S-28	FASCIA STRUT REPAIRS		
S-04	PROJECT NOTES AND QUANTITIES	S-29	ARCH LATERAL BRACING REPAIRS		
S-05	STAGE CONSTRUCTION (1 OF 3)	S-30	COLUMN REPAIRS		
S-06	STAGE CONSTRUCTION (2 OF 3)	S-31	CONNECTION REPAIRS (1 OF 2)		
S-07	STAGE CONSTRUCTION (3 OF 3)	S-32	CONNECTION REPAIRS (2 OF 2)		
S-08	SUGGESTED STAGING & WATER HANDLING PLAN	S-33	SUGGESTED TEMPORARY PLATE DETAIL		
S-09	SUGGESTED TEMPORARY ACCESS PLATFORM	S-34	DECK JOINT DETAILS		
S-10	CONCRETE REPAIR DETAILS (1 OF 2)	S-35	TROUGH DETAILS		
S-11	CONCRETE REPAIR DETAILS (2 OF 2)	S-36	BRIDGE RAILING (1 OF 4)		
S-12	ABUTMENT 1 AND 2 REPAIRS	S-37	BRIDGE RAILING (2 OF 4)		
S-13	PIER 1 REPAIRS	S-38	BRIDGE RAILING (3 OF 4)		
S-14	PIER 2 REPAIRS	S-39	BRIDGE RAILING (4 OF 4)		
S-15	PIER 3 REPAIRS	S-40	TWO TUBE RETROFIT BRIDGE RAILING DETAILS		
S-16	PIER 4 REPAIRS	S-41	MERRITT PARKWAY MEDIAN BARRIER (BRIDGE)		
S-17	PIER 5 REPAIRS	S-42	TEMPORARY PRECAST CONCRETE BARRIER CURB (STRUCTURE)		
S-18	PIER 6 REPAIRS				
S-19	APPROACH REPAIRS (1 OF 2)				
S-20	APPROACH REPAIRS (2 OF 2)				
S-21	PIER CAP REPAIR				
S-22	CORBEL REPAIR				
S-23	DECK PATCHING				
S-24	STEEL FRAMING PLAN				
S-25	ARCH RIB REPAIRS (1 OF 2)				

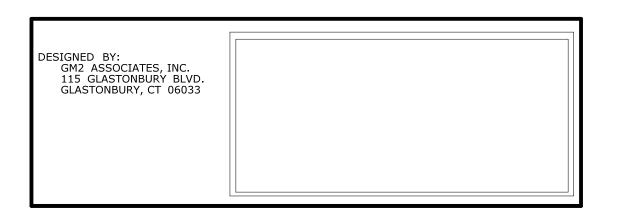

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REV.	DATE	REVISION DESCRIPTION	SHEET NO.	Plotted Date: 7/6/2016

STATE OF CONNECTICUT
DEPARTMENT OF TRANSPORTATION


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EHABILITATION OF BRIDGE 00728	
<b>MERRITT PARKWAY</b>	DRA
OVER SAUGATUCK RIVER	

N:		PROJECT NO.
	WESTPORT	158-207
		DRAWING NO.
WING TITLE:		─ S-01
	INDEX OF	SHEET NO.
	DRAWINGS	05.03.01



#### **GENERAL NOTES:**

SPECIFICATIONS: CONNECTICUT DEPARTMENT OF TRANSPORTATION FORM 816 (2004). SUPPLEMENTAL SPECIFICATIONS DATED JANUARY 2016 AND SPECIAL PROVISIONS.

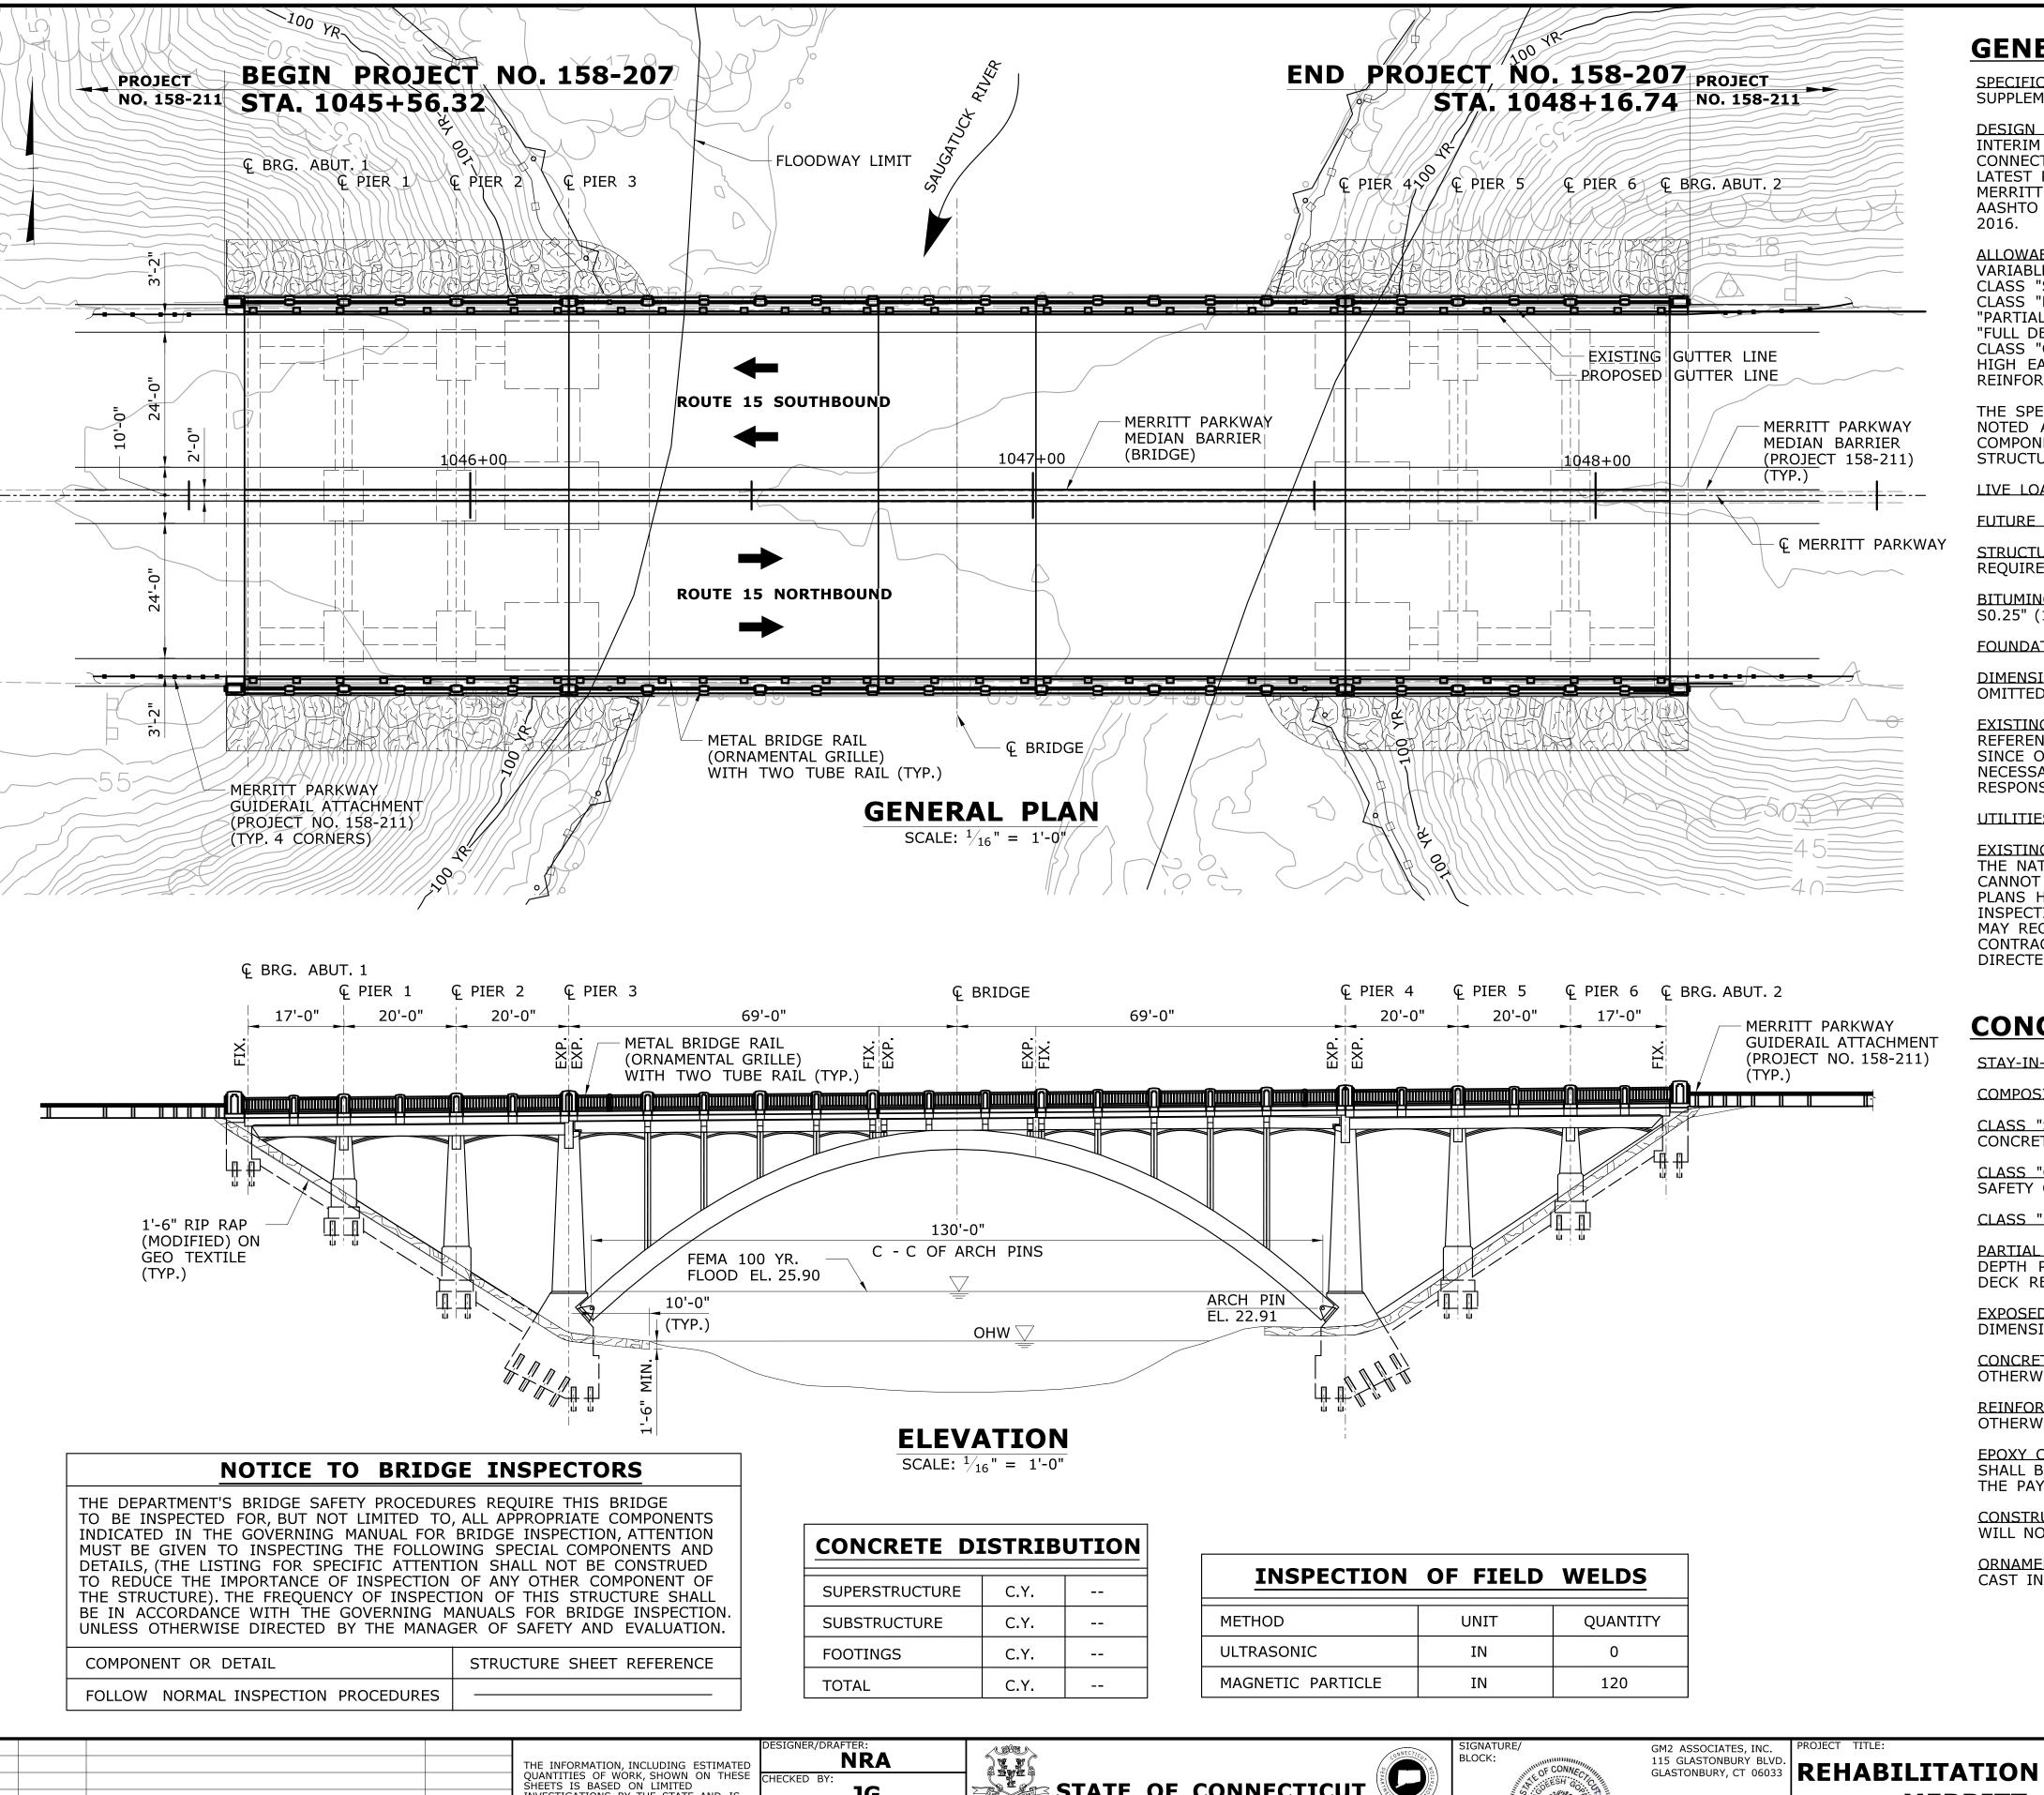DESIGN SPECIFICATION: AASHTO LRFD DESIGN SPECIFICATIONS, 7TH EDITION (2014), WITH THE INTERIM SPECIFICATIONS UP TO AND INCLUDING (2016), AS SUPPLEMENTED BY THE CONNECTICUT DEPARTMENT OF TRANSPORTATION BRIDGE DESIGN MANUAL (2003), WITH THE LATEST REVISIONS.

MERRITT PARKWAY BRIDGE RESTORATION GUIDE. AASHTO MANUAL FOR BRIDGE EVALUATION 2ND EDITION WITH INTERIMS UP TO AND INCLUDING

ALLOWABLE DESIGN STRESSES:

VARIABLE DEPTH PATCH FOR HISTORIC BASED ON f'c=4,000 psi CLASS "S" CONCRETE FOR HISTORICAL BRIDGES: f'c=4,000 psi

CLASS "F" CONCRETE: f'c=4,000 psi "PARTIAL DEPTH PATCH" CONCRETE: SEE SPECIAL PROVISIONS

"FULL DEPTH PATCH (HIGH EARLY STRENGTH CONCRETE)": SEE SPECIAL PROVISIONS

CLASS "C" CONCRETE - REPLICATED: f'c=4,000 psi

HIGH EARLY STRENGTH CONCRETE BASED ON f'c=4,000 psi REINFORCEMENT (ASTM A615, GRADE 60), FY= 60,000 psi

THE SPECIFIED CONCRETE STRENGTH USED IN DESIGN, f'c, OF THE CONCRETE COMPONENTS IS NOTED ABOVE. THE MINIMUM COMPRESSIVE STRENGTH OF THE CONCRETE IN THE CONSTRUCTED COMPONENTS SHALL CONFORM TO THE REQUIREMENTS OF "SECTION 6.01 CONCRETE FOR STRUCTURES."

LIVE LOAD: SEE DRAWING S-04

**FUTURE PAVING ALLOWANCE: NONE.** 

STRUCTURAL STEEL: SEE STRUCTURAL STEEL NOTES ON DWG. S-24 FOR DESIGNATIONS AND

BITUMINOUS CONCRETE OVERLAY: THIS SHALL CONSIST OF TWO LIFTS: THE FIRST SHALL BE "HMA S0.25" (1" THICK) AND THE SECOND LIFT SHALL BE "HMA S0.5" (2" THICK).

FOUNDATION PRESSURES: N/A

<u>DIMENSIONS</u>: WHEN DECIMAL DIMENSIONS ARE GIVEN LESS THAN THREE DECIMAL PLACES, THE OMITTED DIGITS SHALL BE ASSUMED TO BE ZEROS.

EXISTING DRAWINGS: PLANS OF THE EXISTING STRUCTURE ARE INCLUDED FOR GENERAL REFERENCE ONLY AND MAY NOT DEPICT AS-BUILT CONDITIONS NOR ALL MODIFICATIONS MADE SINCE ORIGINAL CONSTRUCTION. THE CONTRACTOR SHALL TAKE ALL FIELD MEASUREMENTS NECESSARY TO ASSURE PROPER FIT OF THE FINISHED WORK AND SHALL ASSUME FULL RESPONSIBILITY FOR THEIR ACCURACY.

**UTILITIES:** N/A

EXISTING CONDITIONS: THE CONTRACTOR'S ATTENTION IS DIRECTED TO THE FACT THAT DUE TO THE NATURE OF REHABILITATION PROJECTS, THE EXACT EXTENT OF REHABILITATION WORK CANNOT ALWAYS BE ACCURATELY DETERMINED PRIOR TO THE COMMENCEMENT OF WORK. THESE PLANS HAVE BEEN PREPARED BASED ON LIMITED FIELD INVESTIGATIONS AND BRIDGE INSPECTION REPORTS, AVAILABLE AT THE TIME. THE ACTUAL FIELD CONDITIONS MAY VARY AND MAY REQUIRE MODIFICATIONS TO CONSTRUCTION DETAILS AND WORK QUANTITIES. THE CONTRACTOR SHALL PERFORM ALL WORK IN ACCORDANCE WITH FIELD CONDITIONS AND AS DIRECTED BY THE ENGINEER.

#### **CONCRETE NOTES:**

STAY-IN-PLACE FORMS: N/A

COMPOSITE CONSTRUCTION: N/A

CLASS "S" CONCRETE: CLASS "S" CONCRETE FOR HISTORIC BRIDGES SHALL BE USED FOR ALL CONCRETE REPAIRS EXCEPT DECK REPAIRS.

CLASS "C" CONCRETE: CLASS "C" CONCRETE SHALL BE USED FOR THE ORNAMENTAL PARAPET, SAFETY CURB AND END BLOCKS.

CLASS "F" CONCRETE: CLASS "F" CONCRETE SHALL BE USED FOR THE MEDIAN BARRIER.

PARTIAL DEPTH PATCH AND FULL DEPTH PATCH (HIGH EARLY STRENGTH CONCRETE): PARTIAL DEPTH PATCH AND FULL DEPTH PATCH (HIGH EARLY STRENGTH CONCRETE) SHALL BE USED IN DECK REPAIRS.

EXPOSED EDGES: EXPOSED EDGES OF CONCRETE SHALL BE BEVELED 1" X 1" UNLESS DIMENSIONED OTHERWISE.

CONCRETE COVER: ALL REINFORCEMENT SHALL HAVE 2" COVER UNLESS DIMENSIONED

REINFORCEMENT: ALL REINFORCEMENT SHALL BE ASTM A615, GRADE 60 UNLESS NOTED OTHERWISE.

EPOXY COATED REINFORCING BARS: ALL REINFORCEMENT IN THE PARAPETS AND END BLOCKS SHALL BE EPOXY COATED UNLESS OTHERWISE NOTED. THESE BARS SHALL BE INCLUDED IN THE PAY ITEM "DEFORMED STEEL BARS (EPOXY COATED)".

CONSTRUCTION JOINTS: CONSTRUCTION JOINTS, OTHER THAN THOSE SHOWN ON THE PLANS, WILL NOT BE PERMITTED WITHOUT PRIOR APPROVAL OF THE ENGINEER.

ORNAMENTAL PARAPET AND ENDBLOCKS: ORNAMENTAL PARAPET AND END BLOCKS SHALL BE CAST IN PLACE.

				THE INFORMATION, INCLUDING ESTIMATED
				QUANTITIES OF WORK, SHOWN ON THESE SHEETS IS BASED ON LIMITED
				INVESTIGATIONS BY THE STATE AND IS IN NO WAY WARRANTED TO INDICATE
				THE CONDITIONS OF ACTUAL QUANTITIES
				OF WORK WHICH WILL BE REQUIRED.
REV.	DATE	REVISION DESCRIPTION	SHEET NO.	Plotted Date: 7/6/2016

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STATE OF CONNECTICUT **DEPARTMENT OF TRANSPORTATION** 




REHABILITATION OF BRIDGE 00728 **MERRITT PARKWAY OVER SAUGATUCK RIVER** 

**WESTPORT** 

158-207 **S-02** 

**GENERAL PLAN** 

SHEET NO. 05.03.02

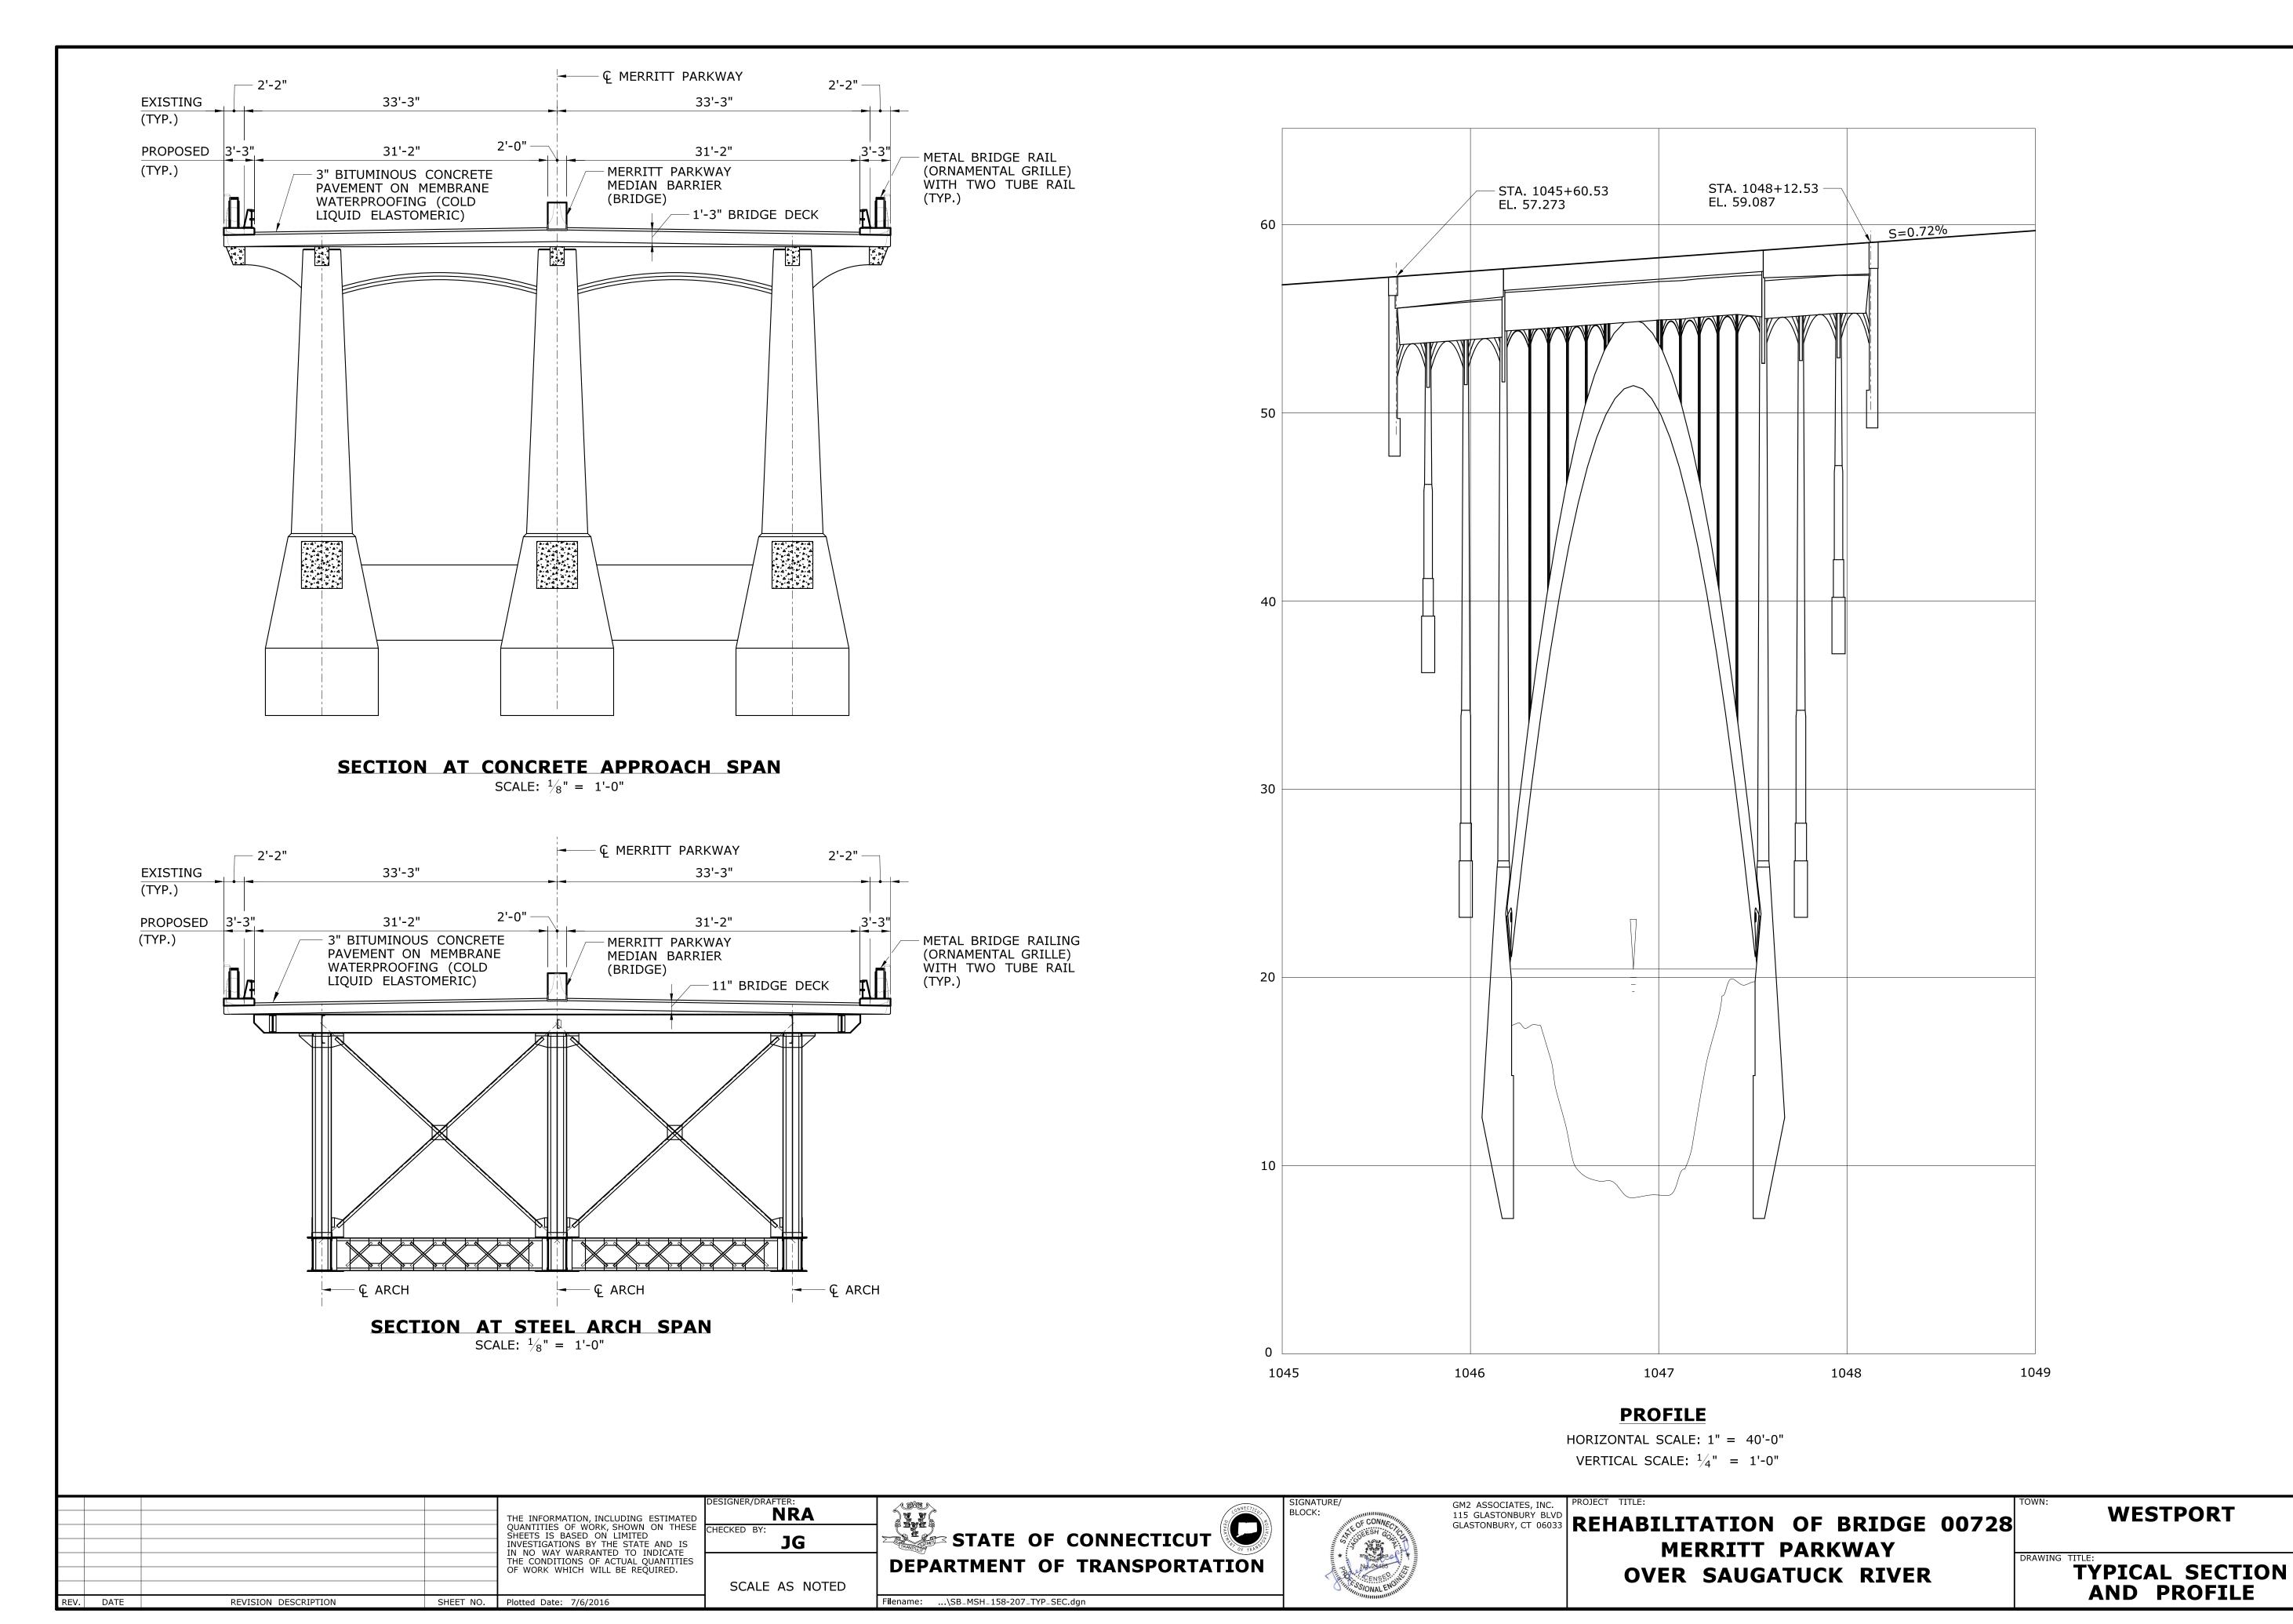

PROJECT NO. **158-207** 

S-03

05.03.03

SHEET NO.

#### **SCOPE OF REHABILITATION**

- 1. DEMOLISH EXISTING PARAPET AND RECONSTRUCT HISTORIC ORNAMENTAL PARAPET WITH
- MERRITT PARKWAY TWO TUBE RAIL. 2. REMOVE EXISTING MEDIAN BARRIER AND INSTALL MERRITT PARKWAY MEDIAN BARRIER
- 3. REMOVE OVERLAY, INSTALL SPRAY-ON WATERPROOFING MEMBRANE AND NEW OVERLAY.
- 4. RECONSTRUCT DECK ENDS AND INSTALL NEW EXPANSION JOINTS.
- 5. PERFORM CONCRETE SUBSTRUCTURE REPAIRS.
- 6. PERFORM DECK REPAIRS.
- 7. PERFORM STEEL REPAIRS
- 8. COAT ENTIRE STRUCTURE WITH HRCSA CORROSION PROTECTION SYSTEM
- 9. INSTALL RIPRAP AS SHOWN ON THE PLANS

#### COORDINATION WITH PROJECT NO. 158-211

- 1. MERRITT PARKWAY GUIDERAIL INCLUDING ATTACHMENTS ARE INCLUDED UNDER THE ITEMS FOR PROJECT #158-211.
- 2. HMA WEARING SURFACE OUTSIDE THE LIMITS OF THE ABUTMENT JOINTS ARE INCLUDED UNDER PROJECT #158-211.
- 3. MERRITT PARKWAY MEDIAN BARRIER NOT ON THE BRIDGE IS INCLUDED UNDER PROJECT #158-211.
- 4. ITEMS FOR MAINTENANCE AND PROTECTION OF TRAFFIC ARE INCLUDED IN THIS CONTRACT. SEE TRAFFIC PLANS.
- 5. ALL OTHER ROADWAY ITEMS ARE INCLUDED UNDER PROJECT #158-211 UNLESS SPECIFICALLY NOTED OTHERWISE.

#### MAINTENANCE AND PROTECTION OF TRAFFIC

- 1. ALL TRAFFIC OPERATIONS MUST COMPLY WITH THE LIMITATIONS OF OPERATIONS IN SECTION 1.08 PROSECUTION AND PROGRESS.
- 2. CONTRACTOR SHALL MAINTAIN AND PROTECT TRAFFIC IN ACCORDANCE WITH THE ITEM "MAINTENANCE AND PROTECTION OF TRAFFIC".
- 3. ALL MAINTENANCE AND PROTECTION OF TRAFFIC SHALL BE COORDINATED WITH PROJECT #158-211.

#### CONSTRUCTION LOADING RESTRICTIONS

- 1. THE CONTRACTOR IS ADVISED TO NOTE THAT DETERIORATION OF THE ARCH RIBS HAVE SIGNIFICANTLY COMPROMISED THE LOAD CARRYING CAPACITY OF THE BRIDGE. THE CONTRACTOR WILL NOT BE ALLOWED TO OPERATE ANY CONSTRUCTION EQUIPMENT ON THE BRIDGE THAT EXCEED THE LOADS LIMITATIONS NOTED ON THIS DRAWING.
- 2. PRIOR TO APPLYING ANY CONSTRUCTION LOADS OR OPERATING ANY EQUIPMENT ON THE BRIDGE, THE CONTRACTOR SHALL SUBMIT FOR REVIEW A DETAILED PLAN OUTLINING HIS MEANS OF ACCESS, EXPLICITLY IDENTIFYING THE ASSUMED LOADS THAT WILL BE IMPOSED ON THE STRUCTURE DURING CONSTRUCTION, AT A MINIMUM, THE FOLLOWING SHALL BE INCLUDED AS PART OF THE SPECIAL PROVISION "CONSTRUCTION ACCESS".

#### A. DEAD LOADS:

WEIGHT OF TEMPORARY ACCESS PLATFORMS, DEBRIS SHIELDS, CONTAINMENT SYSTEMS, SCAFFOLDING AND ANY OTHER COMPONENTS THAT WILL BE SUPPORTED BY THE BRIDGE ON A "PERMANENT" BASIS DURING CONSTRUCTION.

#### B. LIVE LOADS:

REV. DATE

WEIGHT OF PERSONNEL, TEMPORARY SUPPORTS, GENERATORS, COMPRESSORS. PUMPS, LIGHTING FIXTURES, WATER TANKS, VEHICLES, EXCAVATORS AND ANY OTHER EOUIPMENT THAT WILL BE SUPPORTED BY THE BRIDGE ON AN INTERMITTENT BASIS DURING CONSTRUCTION.

#### 3. VEHICULAR LIVE LOAD RESTRICTIONS:

- A. ANY VEHICULAR LIVE LOAD THAT EXCEEDS THE DESIGN LIVE LOADS NOTED ON THIS SHEET WILL NOT PERMITTED ON THE BRIDGE AT ANY GIVEN TIME.
- B. DURING CONSTRUCTION, NO MORE THAN ONE TRUCK AT A TIME SHALL BE ALLOWED TO TRAVEL OVER THE STRUCTURE AT ANY GIVE TIME.
- C. FOR ALL CONSTRUCTION VEHICLES THAT EXCEED THE WEIGHT OF A H-10 TRUCK. THE CONTRACTOR SHALL SUBMIT TO THE ENGINEER FOR REVIEW THE ANTICIPATED AXLE LOADS.
- D. THE STANDARD PAVING TRAIN CANNOT BE USED ON THE STRUCTURE.

#### 4. UNIFORM CONSTRUCTION LOAD RESTRICTIONS:

A. PLATFORMS SHALL BE A LIGHT WEIGHT CABLE SUPPORTED SYSTEM. COMBINED UNIFORM DEAD + LIVE LOADS ON THE STRUCTURE SHALL NOT EXCEED THE FOLLOWING VALUES:

#### DL + CONSTRUCTION LL : 30 PSF

REVISION DESCRIPTION

- B. CONSTRUCTION DEAD LOADS SHALL LOAD THE STRUCTURE SYMMETRICALLY AT ALL TIMES. LOADING SHALL BE SYMMETRIC WITH RESPECT TO THE LONGITUDINAL AS WELL AS TRANSVERSE DIRECTION AND SHALL APPLY TO LOADS APPLIED TO FLOORBEAMS, COLUMNS AND ARCH RIBS.
- C. BRACING ELEMENTS SHALL NOT BE LOADED UNLESS APPROVED BY THE ENGINEER.
- D. CONSTRUCTION LIVE LOADS SHALL BE SYMMETRIC WITH RESPECT TO THE LONGUITUDINAL AS WELL AS TRANSVERSE DIRECTION. THE ENGINEER MAY REQUIRE RELOCATION OF MATERIAL AND OR EQUIPMENT SUPPORTED BY THE STRUCTURE IF HE DEEMS THAT THE LOADING CONDITIONS ARE UNSYMMETRIC IN NATURE.
- E. ANY EQUIPMENT THAT IMPARTS A CONCENTRATED LOAD IN EXCESS OF 5 KIPS TO ANY PART OF THE STRUCTURE WILL NOT BE ALLOWED UNLESS APPROVED BY THE ENGINEER.

#### **DESIGN LIVE LOADS**


- 1. THE REHABILITATION DESIGN OF THE BRIDGE WAS PERFORMED UTILIZING THE FOLLOWING LIVE LOADS:
- A. DESIGN LOADS

HL-93 LANE LOAD ONLY (INVENTORY & OPERATING) 640 PLF


#### B. LEGAL LOADS

WESTPORT EMERGENCY20VEHIC2DEK (SUTPHEN P95), GVW = 63 KIPS **→**4'-6'" →

#### CONNIDOT MAINTENANCE VEHICLE #1, GVW = 36.85 KIPS

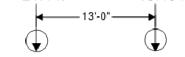

GONNDOT MAINTENANCE VEHICLE #2, GVW = 37.55 KIPS

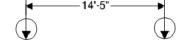

#### C. PERMIT LOADS

5ρ' UNDER BRIDGE INSPECTION VEHICLE (ASPEN UB-50 ASSUMED), GVW = 67.3 KIPS **→** 4"-6" **→** 6'-10" **→** 

#### GENERAL SEQUENCE OF CONSTRUCTION

- 1. THE SEQUENCE OF CONTRUCTION IS AS FOLLOWS:
- A. CREATE MEANS TO PROVIDE ACCESS TO THE BRIDGE AS REQUIRED AND INSTALL SILT FENCE.
- B. INSTALL TEMPORARY WORK PLATFORM ACROSS THE WHOLE BRIDGE AS REQUIRED
- C. INSTALL MONORAIL CRANE SYSTEM OR USE OTHER ALTERNATE METHODS AS REQUIRED TO FACILITATE DELIVERY OF MATERIAL AND EQUIPMENT BELOW THE STRUCTURE.
- D. CONSTRUCT COFFERDAMS AND INSTALL TIMBER MATTING AT THE BOTTOM OF THE ARCH AS
- E. PERFORM COLUMN STRENGTHENING AS SHOWN ON DRAWING S-30.
- F. REMOVE OVERLAY ACROSS THE WHOLE BRIDGE.
- G. INSTALL TEMPORARY PAVEMENT ON THE BRIDGE
- H. GRIND HEADERS DOWN TO RIDING SURFACE AND INSTALL TEMPORARY JOINT.
- I. START STAGE CONSTRUCTION.
- J. PERFORM ARCH RIB REPAIRS AS SHOWN ON DRAWING S-25. ONLY REPAIRS THAT STRENGTHEN THE ARCH RIB SHOULD BE PERFORMED AT THIS TIME.
- K. PERFORM STEEL REPAIRS IN ACCORDANCE WITH THE CONTRACT DOCUMENTS. STEEL REPAIRS THAT REQUIRE THE COLUMN-ARCH RIB CONNECTION TO BE DISCONNECTED SHALL BE PERFORMED DURING THE APPROPRIATE STAGE OF CONSTRUCTION WHERE THE LOAD ON THE ARCH RIB IS MINIMIZED.
- L. PERFORM SUBSTRUCTURE CONCRETE REPAIRS. SOME REPAIRS WILL REQUIRE TEMPORARY SHORING OF THE PIER CAPS.
- M. RECONSTRUCT BRIDGE RAILING SYSTEM DURING APPROPRIATE STAGE OF CONSTRUCTION AS SHOWN ON STAGE CONSTRUCTION DRAWINGS.
- N. APPLY HRCSA CORROSION PROTECTION SYSTEM TO ALL STEEL COMPONENTS.
- O. REMOVE STEEL TEMPORARY DECK PLATE AND RECONSTRUCT DECK ENDS AS SHOWN ON DWG S-34.
- P. INSTALL DECK JOINTS.
- Q. REMOVE TEMPORARY PAVEMENT AND INSTALL NEW MEMBRANE WATERPROOFING AND PAVE THE BRIGE.
- R. REMOVE COFFERDAM AND PLACE RIPRAP BELOW THE BRIDGE.
- S. REMOVE TEMPORARY SUPPORT SYSTEM
- T. PLACE THE REST OF THE RIPRAP, REMOVE SILT FENCE AND RESTORE THE SITE TO ORIGINAL

#### ITEM DESCRIPTION UNIT TOTAL LEAD COMPLIANCE FOR MISCELLANEOUS EXTERIOR TASKS L.S. **CONSTRUCTION ACCESS** L.S. REMOVAL OF HMA WEARING SURFACE S.Y. 1872 CUT BITUMINOUS CONCRETE PAVEMENT L.F. 133 HANDLING WATER L.S. SEDIMENTATION CONTROL SYSTEM L.F. 221 PROCESSED AGGREGATE BASE C.Y. 300 TEMPORARY PAVEMENT S.Y. 3744 HMA S0.5 TON 198 HMA S0.25 TON 119 FINE MILLING OF BITUMINOUS CONCRETE (0 TO 4 INCHES) S.Y. 370 CLEAN HISTORIC CONCRETE BRIDGE (SITE NO. 3) L.S. 1 JACKING EXISTING BEAMS EA. RECONSTRUCT CONCRETE DECK ENDS C.Y. 15 ASPHALTIC PLUG EXPANSION JOINT SYSTEM C.F. 26 PREFORMED JOINT SEAL 250 PARTIAL DEPTH PATCH C.Y. 23 FULL DEPTH PATCH (HIGH EARLY STRENGTH CONCRETE) C.Y. 71 CLASS "S" CONCRETE FOR HISTORIC BRIDGES C.F. 636 CLASS "C" CONCRETE - REPLICATED C.Y. 64 VARIABLE DEPTH PATCH FOR HISTORIC CONCRETE BRIDGES C.F. REMOVAL OF GRAFFITI FROM HISTORIC CONCRETE S.F. 10 TESTING AND ANALYSIS OF HISTORIC CONCRETE EA. DEFORMED STEEL BARS LBS. 7067 DEFORMED STEEL BARS - EPOXY COATED LBS. 12900 DRILLING HOLES AND GROUTING DOWELS EA. 3220 DISPOSAL OF LEAD DEBRIS BBL. 10 TEMPORARY DECK PLATE LF. 258 REPLACE REMOVED OR MISSING RIVETS AND BOLTS WITH HIGH STRENGTH BOLTS EA. 300 EMBEDDED GALVANIC ANODES EA. 2914 REHABILITATION OF EXISTING STRUCTURAL STEEL TEMPORARY SUPPORT SYSTEM (SITE NO. 3) L.S. HRCSA CORROSION PROTECTION SYSTEM L.S. MODIFIED RIPRAP C.Y. 352 MEMBRANE WATERPROOFING (COLD LIQUID ELASTOMERIC) S.Y. 1811 GEOTEXTILE (SEPARATION - MEDIUM SURVIVABILITY) S.Y. 703 MERRITT PARKWAY MEDIAN BARRIER (BRIDGE) L.F. 254 TEMPORARY PRECAST CONCRETE BARRIER CURB (STRUCTURE) L.F. 254 RELOCATED TEMPORARY PRECAST CONCRETE BARRIER CURB (STRUCTURE) L.F. 1520 TWO TUBE RETROFIT BRIDGE RAIL L.F. 507 METAL BRIDGE RAIL (ORNAMENTAL GRILLE) L.F. 507 REMOVAL OF EXISTING MASONRY LIMITED METHODS C.Y. 83

**BRIDGE QUANTITIES** 

THE INFORMATION, INCLUDING ESTIMATED QUANTITIES OF WORK, SHOWN ON THESE SHEETS IS BASED ON LIMITED INVESTIGATIONS BY THE STATE AND IS NO WAY WARRANTED TO INDICATE THE CONDITIONS OF ACTUAL QUANTITIES OF WORK WHICH WILL BE REQUIRED.

SHEET NO. Plotted Date: 7/6/2016

SC/NRA JG

SCALE AS NOTED

STATE OF CONNECTICUT DEPARTMENT OF TRANSPORTATION



115 GLASTONBURY BLV GLASTONBURY, CT 06033

**MERRITT PARKWAY** 


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158-207 DRAWING NO. **S-04** SHEET NO.

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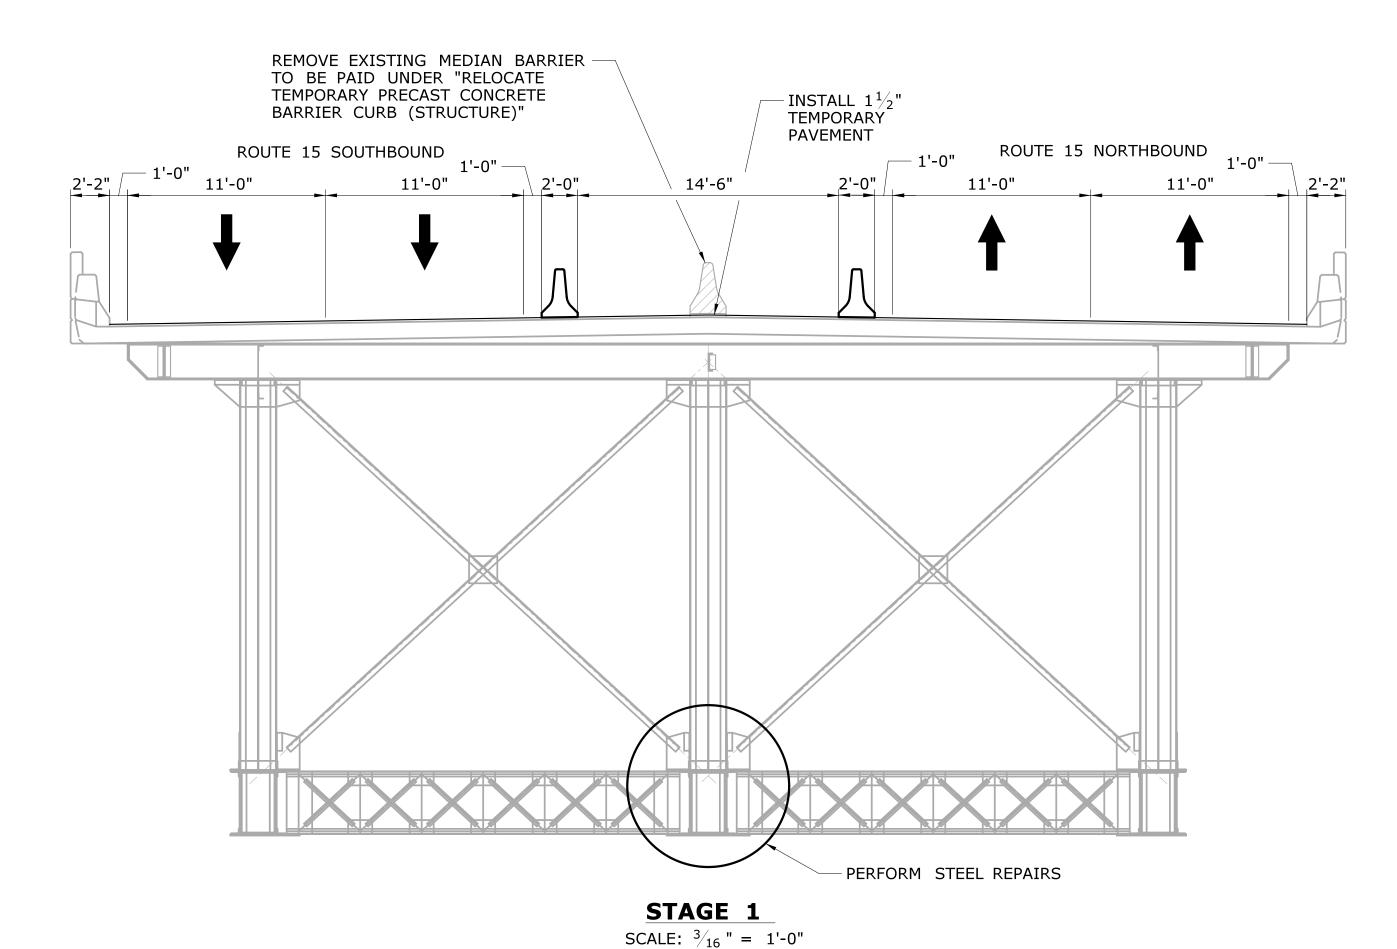
REHABILITATION OF BRIDGE 00728 **OVER SAUGATUCK RIVER** 

PROJECT NOTES AND QUANTITIES 05.03.04



#### **EXISTING**

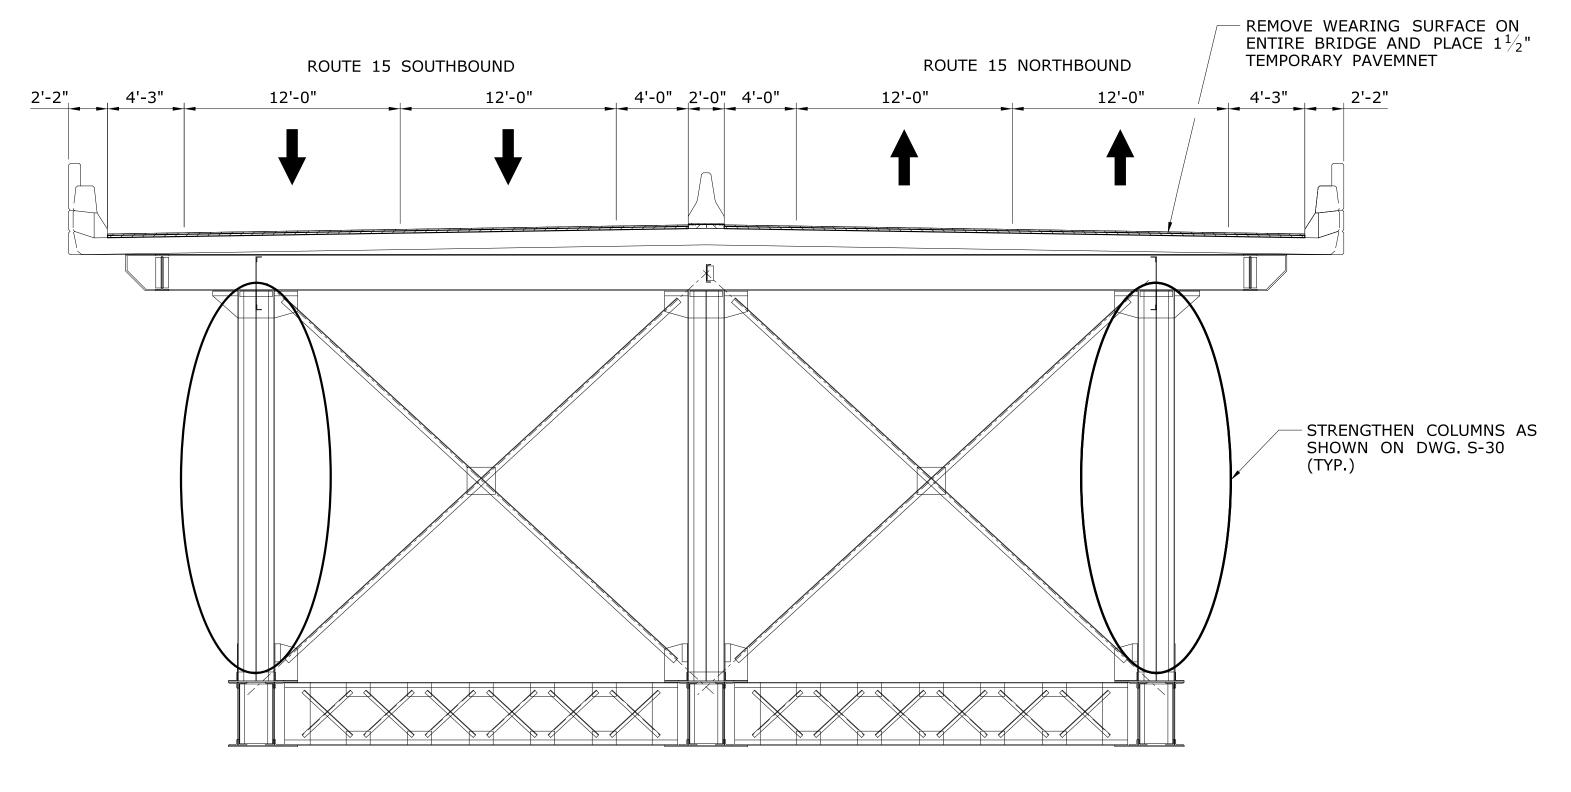SCALE:  $\frac{3}{16}$ " = 1'-0"



#### PRIOR TO STAGE 1 CONSTRUCTION


DURING THE ALLOWABLE HOURS IN ACCORDANCE WITH LIMITATIONS OF OPERATION AND UTILIZING STANDARD TRAFFIC CONTROL PLANS.


- 1. REMOVE EXISTING BITUMINOUS OVERLAY TO EXPOSE THE CONCRETE DECK.
- 2. REMOVE EXISTING EXPANSION JOINTS ON THE BRIDGE.
- 3. GRIND PORTION OF THE HEADERS DOWN TO RIDING SURFACE FOR TEMPORARY PAVEMENT. COST TO BE INCLUDED UNDER REMOVAL OF HMA WEARING SURFACE.
- 4. INSTALL TEMPORARY JOINT SEAL DURING CONSTRUCTION FOR EXPANSION JOINT IN ACCORDANCE WITH SECTION M.03.08 JOINT SEALER FOR STRUCTURES AND COST TO BE INCLUDED UNDER GENERAL COST OF THE PROJECT.
- 4. INSTALL  $1\frac{1}{2}$ " TEMPORARY PAVEMENT IN ACCORDANCE WITH SPECIAL PROVISION "TEMPORARY PAVEMENT".
- 5. PERFORM COLUMN REPAIRS.

#### **STAGE 1 CONSTRUCTION**

- 1. REMOVE EXISTING PAVEMENT MARKINGS AND INSTALL NEW PAVEMENT MARKINGS AND SIGNING AS SHOWN IN THE MPT PLANS.
- 2. SHIFT SOUTHBOUND LANES TOWARDS THE NORTH OF THE STRUCTURE AND NORTHBOUND LANES TOWARDS THE SOUTH OF THE STRUCTURE.
- 3. INSTALL TEMPORARY PRECAST CONCRETE BARRIER CURB (TPCBC) AND REMOVE EXISTING MEDIAN BARRIER CURB ON THE BRIDGE.
- 4. INSTALL  $1\frac{1}{2}$ " TEMPORARY PAVEMENT IN THE MEDIAN PORTION.
- 5. PERFORM STEEL REPAIRS TO ARCH 2.
- 6. PERFORM CONCRETE DECK PATCHING AS SHOWN ON DWG S-23 AND SUBSTRUCTURE REPAIRS. SOME CONCRETE DECK PATCHING MAY NEED TO BE DONE UTILIZING TEMPORARY LANE CLOSURES. REMOVE AND REINSTALL TEMPORARY PAVEMENT AS NEEDED.

	THE INFORMATION, INCLUDING ESTIMATE	DESIGNER/DRAFTER: SC/NRA	SIGNATURE/ BLOCK:	GM2 ASSOCIATES, INC.  115 GLASTONBURY BLVD GLASTONBURY, CT 06033  REHABILITA	TION OF BRIDGE 00728	WESTPORT	PROJECT NO. <b>158-207</b>
	SHEETS IS BASED ON LIMITED INVESTIGATIONS BY THE STATE AND IS IN NO WAY WARRANTED TO INDICATE THE CONDITIONS OF ACTUAL QUANTITIES	JG	STATE OF CONNECTICUT	is an Good Control of the Control of	RITT PARKWAY	DRAWING TITLE:	DRAWING NO.  S-05
	OF WORK WHICH WILL BE REQUIRED.	SCALE AS NOTED	DEPARTMENT OF TRANSPORTATION	CENSES OVER S	AUGATUCK RIVER	STAGE CONSTRUCTION (1 OF 3)	SHEET NO. <b>05.03.05</b>
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#### **STAGE 2 CONSTRUCTION**

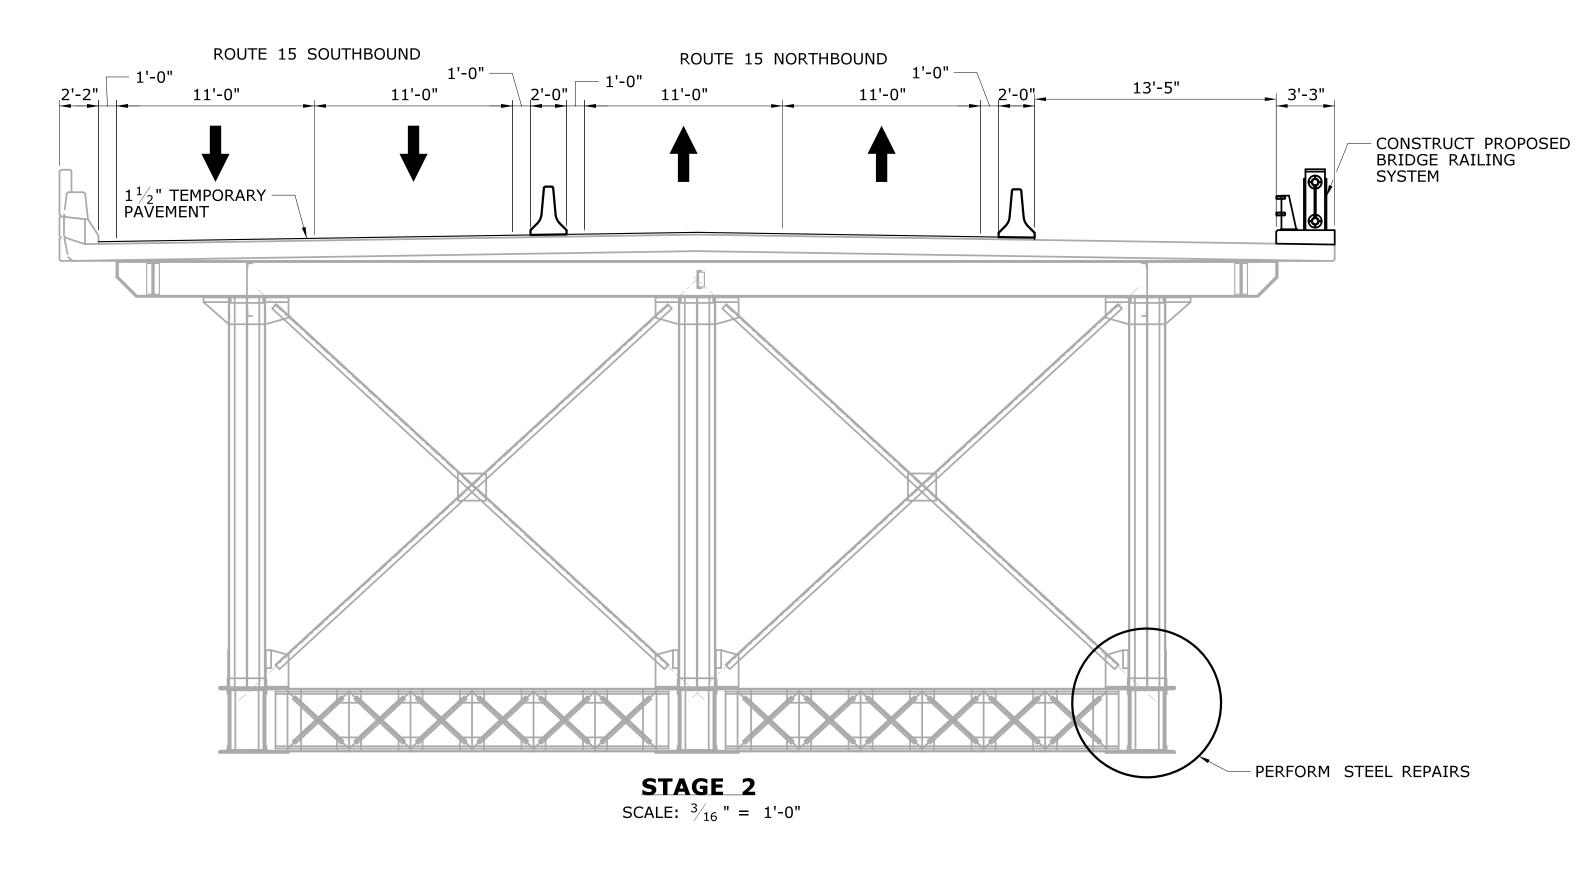- 1. DURING STAGE 2 CONSTRUCTION ALL LANES ARE SHIFTED TOWARDS THE NORTH OF THE STRUCTURE.
- 2. REMOVE TPCBC ON THE SOUTH SIDE OF THE BARRIER.
- 3. REMOVE CONFLICTING PAVEMENT MARKINGS AND INSTALL NEW PAVEMENT MARKINGS AND SIGNING AS SHOWN IN THE MPT PLAN.
- 4. SHIFT THE NORTHBOUND LANES TO THIS NEW ALIGNMENT.
- 5. INSTALL TPCBC AS SHOWN IN THE MPT PLANS.
- 6. REMOVE TEMPORARY PAVEMENT ON THE BRIDGE.
- 7. PERFORM STEEL REPAIRS TO ARCH 3.
- 8. CONSTRUCT BRIDGE RAILING SYSTEM ON NORTHBOUND SIDE.
- 9. PERFORM CONCRETE DECK PATCHING AS SHOWN ON DWG S-23 AND SUBSTRUCTURE REPAIRS.SOME CONCRETE DECK PATCHING MAY NEED TO BE DONE UTILIZING TEMPORARY LANE CLOSURES. REMOVE AND REINSTALL TEMPORARY PAVEMENT AS NEEDED.
- 10. INSTALL TEMPORARY PAVEMENT ON THE PATCHED DECK PORTION.
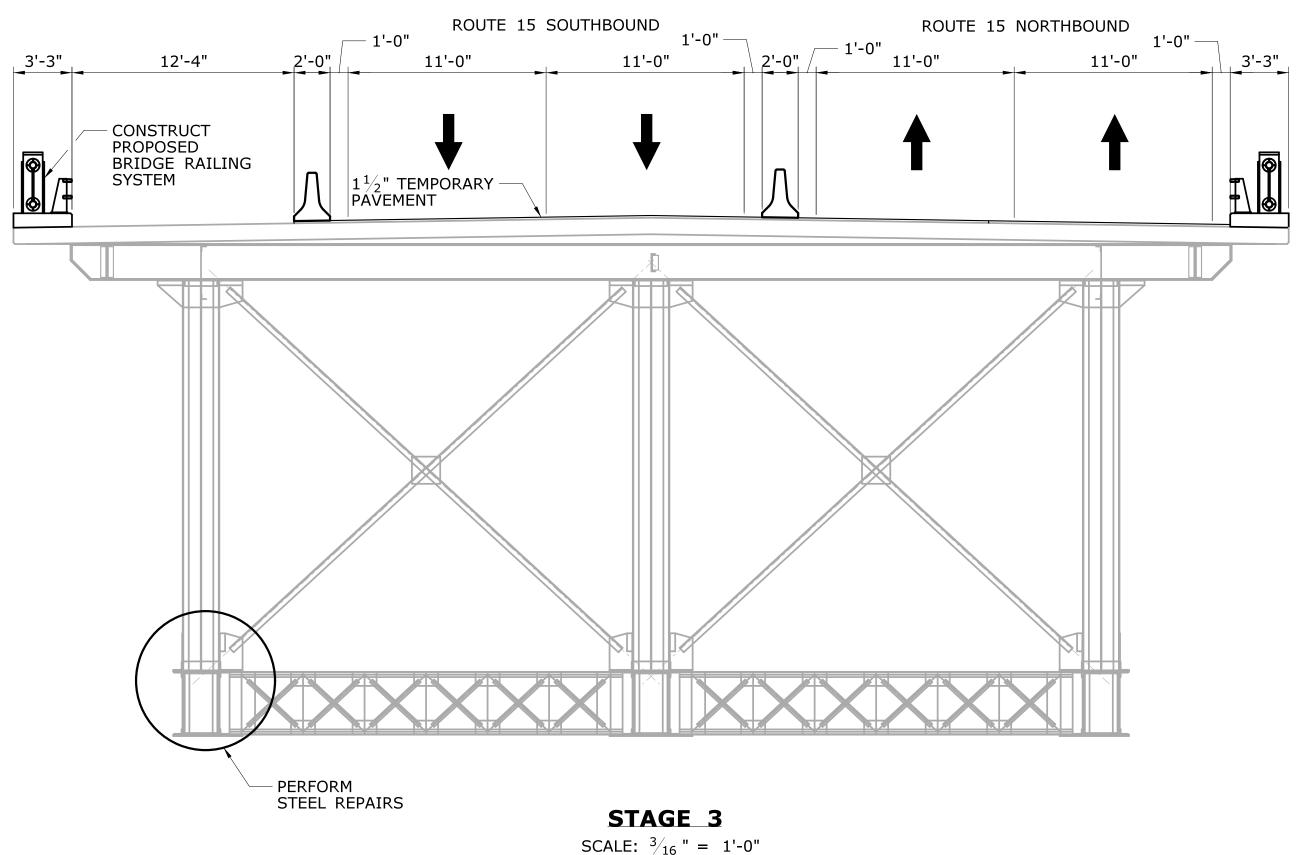
#### **STAGE 3 CONSTRUCTION**

- 1. DURING STAGE 3 CONSTRUCTION ALL LANES ARE SHIFTED TOWARDS THE SOUTH OF THE STRUCTURE.
- 2. REMOVE THE TPCBC ON THE SOUTH SIDE OF THE NORTHBOUND LANES.
- 3. REMOVE CONFLICTING PAVEMENT MARKINGS AND INSTALL NEW PAVEMENT MARKINGS AND SIGNING AS SHOWN IN THE MPT PLANS.
- 4. SHIFT NORTHBOUND TRAFFIC TO THE NEW ALIGNMENT.
- 5. REMOVE THE TPCBC BETWEEN THE NORTHBOUND AND SOUTHBOUND LANES.
- 6. REMOVE CONFLICTING PAVEMENT MARKINGS AND INSTALL NEW PAVEMENT MARKINGS AND SIGNING AS SHOWN IN THE MPT PLANS.
- 7. SHIFT SOUTHBOUND TRAFFIC TO THE NEW ALIGNMENT.
- 8. INSTALL THE TPCBC ON THE NORTH SIDE OF THE BRIDGE.
- 9. REMOVE TEMPORARY PAVEMENT ON THE BRIDGE WHERE DECK PATCHING IS TO BE PERFORMED.
- 10. PERFORM STEEL REPAIRS TO ARCH 1.
- 11. CONSTRUCT BRIDGE RAILING SYSTEM ON SOUTHBOUND SIDE.
- 12. PERFORM CONCRETE DECK PATCHING AS SHOWN ON DWG S-23 AND SUBSTRUCTURE REPAIRS. SOME CONCRETE DECK PATCHING MAY NEED TO BE DONE UTILIZING TEMPORARY LANE CLOSURES. REMOVE AND REINSTALL TEMPORARY PAVEMENT AS NEEDED.
- 13. RECONSTRUCT CORBELS AT PIERS 3 & 4 NORTH OF THE BRIDGE.
- 14. INSTALL TEMPORARY PAVEMENT ON PATCHED PORTION OF THE DECK.

SIGNATURE/ BLOCK:  GM2 ASSOCIATES, INC. 115 GLASTONBURY BLVD GLASTONBURY, CT 06033  REHABILITATIC MERRIT OVER SAU	ONNECTIC PLOCK	SCALE AS NOTED	THE INFORMATION, INCLUDING ESTIMATED QUANTITIES OF WORK, SHOWN ON THESE SHEETS IS BASED ON LIMITED INVESTIGATIONS BY THE STATE AND IS IN NO WAY WARRANTED TO INDICATE THE CONDITIONS OF ACTUAL QUANTITIES OF WORK WHICH WILL BE REQUIRED.			
- MANDIMO	Filename:\SB_MSH_158-207_STAGE_CONSTRUCTION_2.dgn		Plotted Date: 7/6/2016	SHEET NO.	REVISION DESCRIPTION	DATE

REHABILITATION OF BRIDGE 00728

MERRITT PARKWAY

OVER SAUGATUCK RIVER


WESTPORT

RAWING TITLE:


STAGE CONSTRUCTION
(2 OF 3)

DRAWING NO. **S-06**SHEET NO. **05.03.06** 

158-207

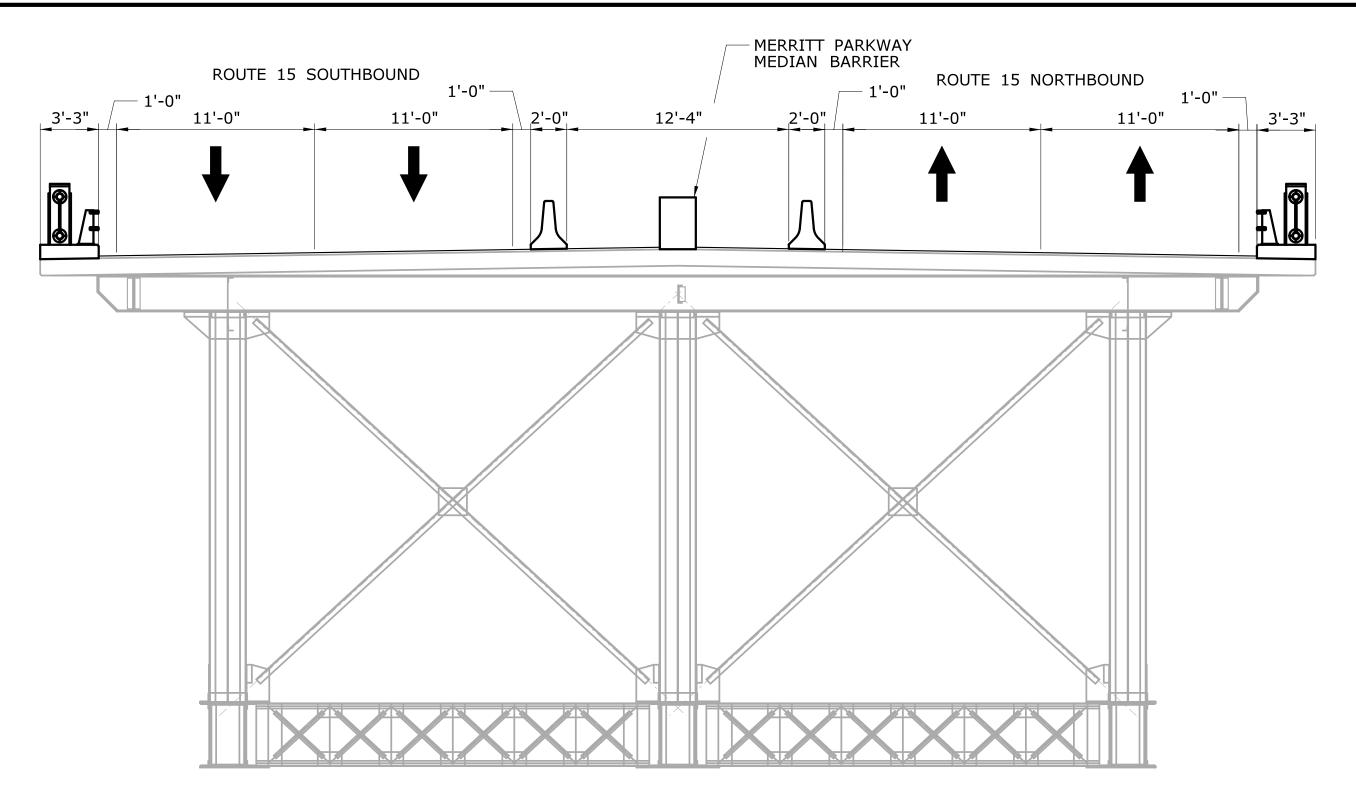

#### STAGE 4 SCALE: $\frac{3}{16}$ " = 1'-0"

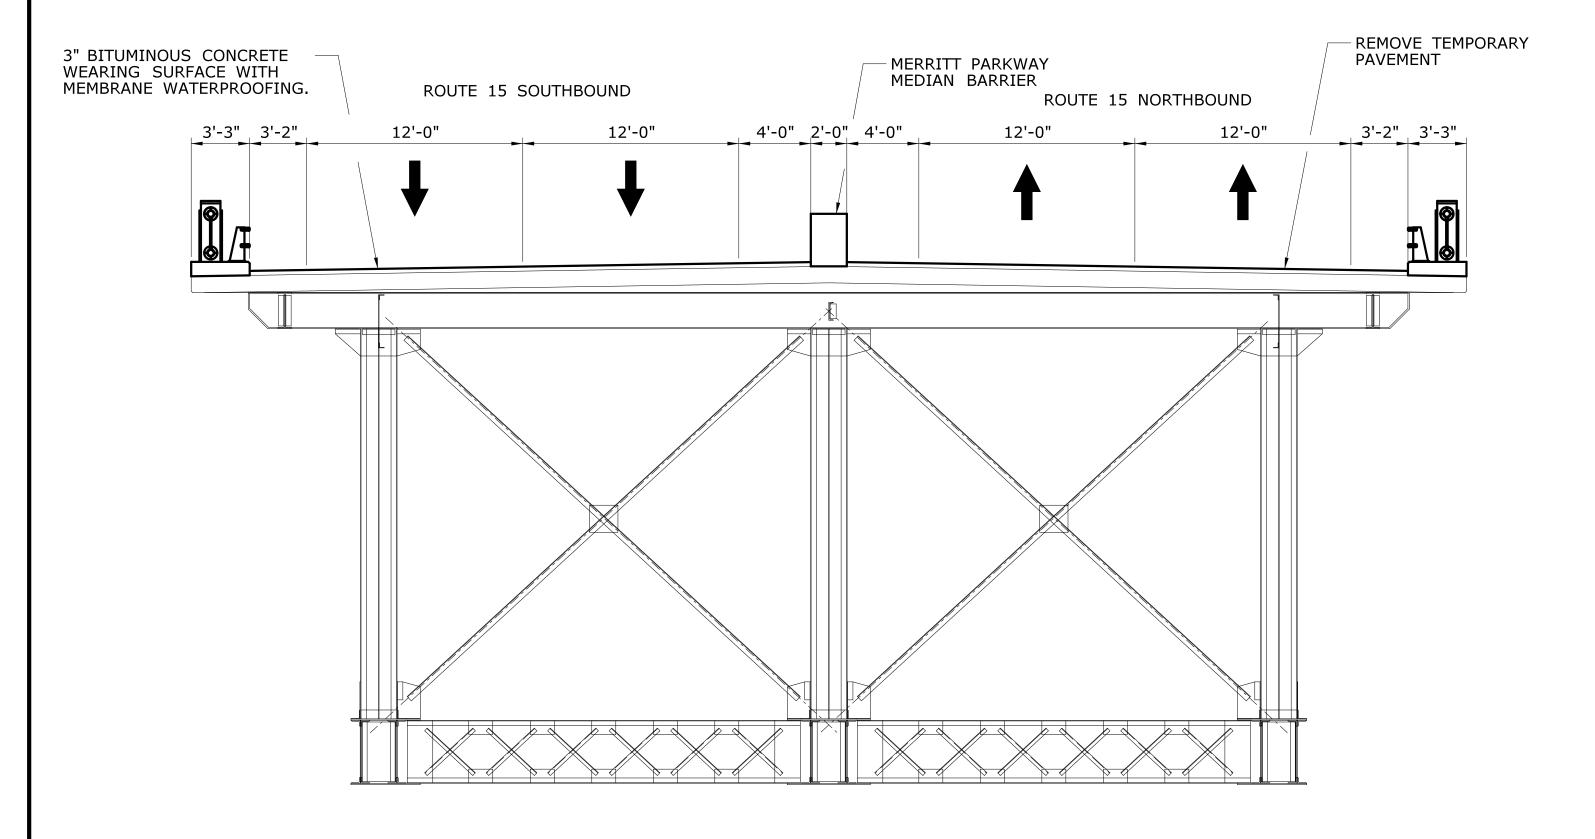

**FINAL** SCALE:  $\frac{3}{16}$ " = 1'-0"

## **STAGE 4 CONSTRUCTION**

- 1. DURING STAGE 4 CONSTRUCTION SHIFT THE SOUTHBOUND LANES TO THE NORTH OF THE STRUCTURE.
- 2. REMOVE THE TPCBC ON THE NORTH SIDE OF THE ROAD.
- 3. REMOVE CONFLICTING PAVEMENT MARKINGS AND SIGNING AND INSTALL NEW PAVEMENT MARKINGS AND SIGNING AS SHOWN IN THE MPT PLANS.
- 4. SHIFT THE SOUTHBOUND TRAFFIC TO THE NEW ALIGNMENT.
- 5. INSTALL TPCBC ON THE SOUTH SIDE OF THE NORTHBOUND LANES.
- 6. REMOVE TEMPORARY PAVEMENT WHEREVER NECESSARY TO PERFORM DECK PATCHING AND CONSTRUCTING MEDIAN BARRIER.
- 7. CONSTRUCT MERRITT PARKWAY MEDIAN BARRIER.
- 8. PERFORM CONCRETE DECK PATCHING AS SHOWN ON DWG S-23. SOME CONCRETE DECK PATCHING MAY NEED TO BE DONE UTILIZING TEMPORARY LANE CLOSURES. REMOVE AND REINSTALL TEMPORARY PAVEMENT AS NEEDED.
- 9. INSTALL TEMPORARY PAVEMENT ON PATCHED DECK.

#### **FINAL CONSTRUCTION**

- 1. REMOVE THE TPCBC.
- 2. REMOVE CONFLICTING PAVEMENT MARKINGS AND SIGNING.
- 3. INSTALL TEMPORARY PAVEMENT MARKINGS IN THE FINAL ALIGNMENT.
- 4. RECONSTRUCT CONCRETE DECK ENDS AS SHOWN ON DWG. S-34.
- 5. INSTALL NEW JOINTS IN CONCRETE HEADERS.
- 6. REMOVE TEMPORARY PAVEMENT ON THE ENTIRE BRIDGE.
- 7. INSTALL MEMBRANE WATERPROOFING ON THE BRIDGE.
- 8. REPAVE THE BRIDGE.
- 9. INSTALL FINAL PAVEMENT MARKINGS AND SIGNING.

				THE INFORMATION, INCLUDING ESTIMATED
				QUANTITIES OF WORK, SHOWN ON THESE SHEETS IS BASED ON LIMITED
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				THE CONDITIONS OF ACTUAL QUANTITIES OF WORK WHICH WILL BE REQUIRED.
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REV.	DATE	REVISION DESCRIPTION	SHEET NO.	Plotted Date: 7/6/2016

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SCALE AS NOTED






GM2 ASSOCIATES, INC.
115 GLASTONBURY BLVD
GLASTONBURY, CT 06033 REHABILITATION OF BRIDGE 00728 **MERRITT PARKWAY OVER SAUGATUCK RIVER** 

PROJECT NO. **158-207 WESTPORT** S-07

STAGE CONSTRUCTION (3 OF 3)

SHEET NO. 05.03.07

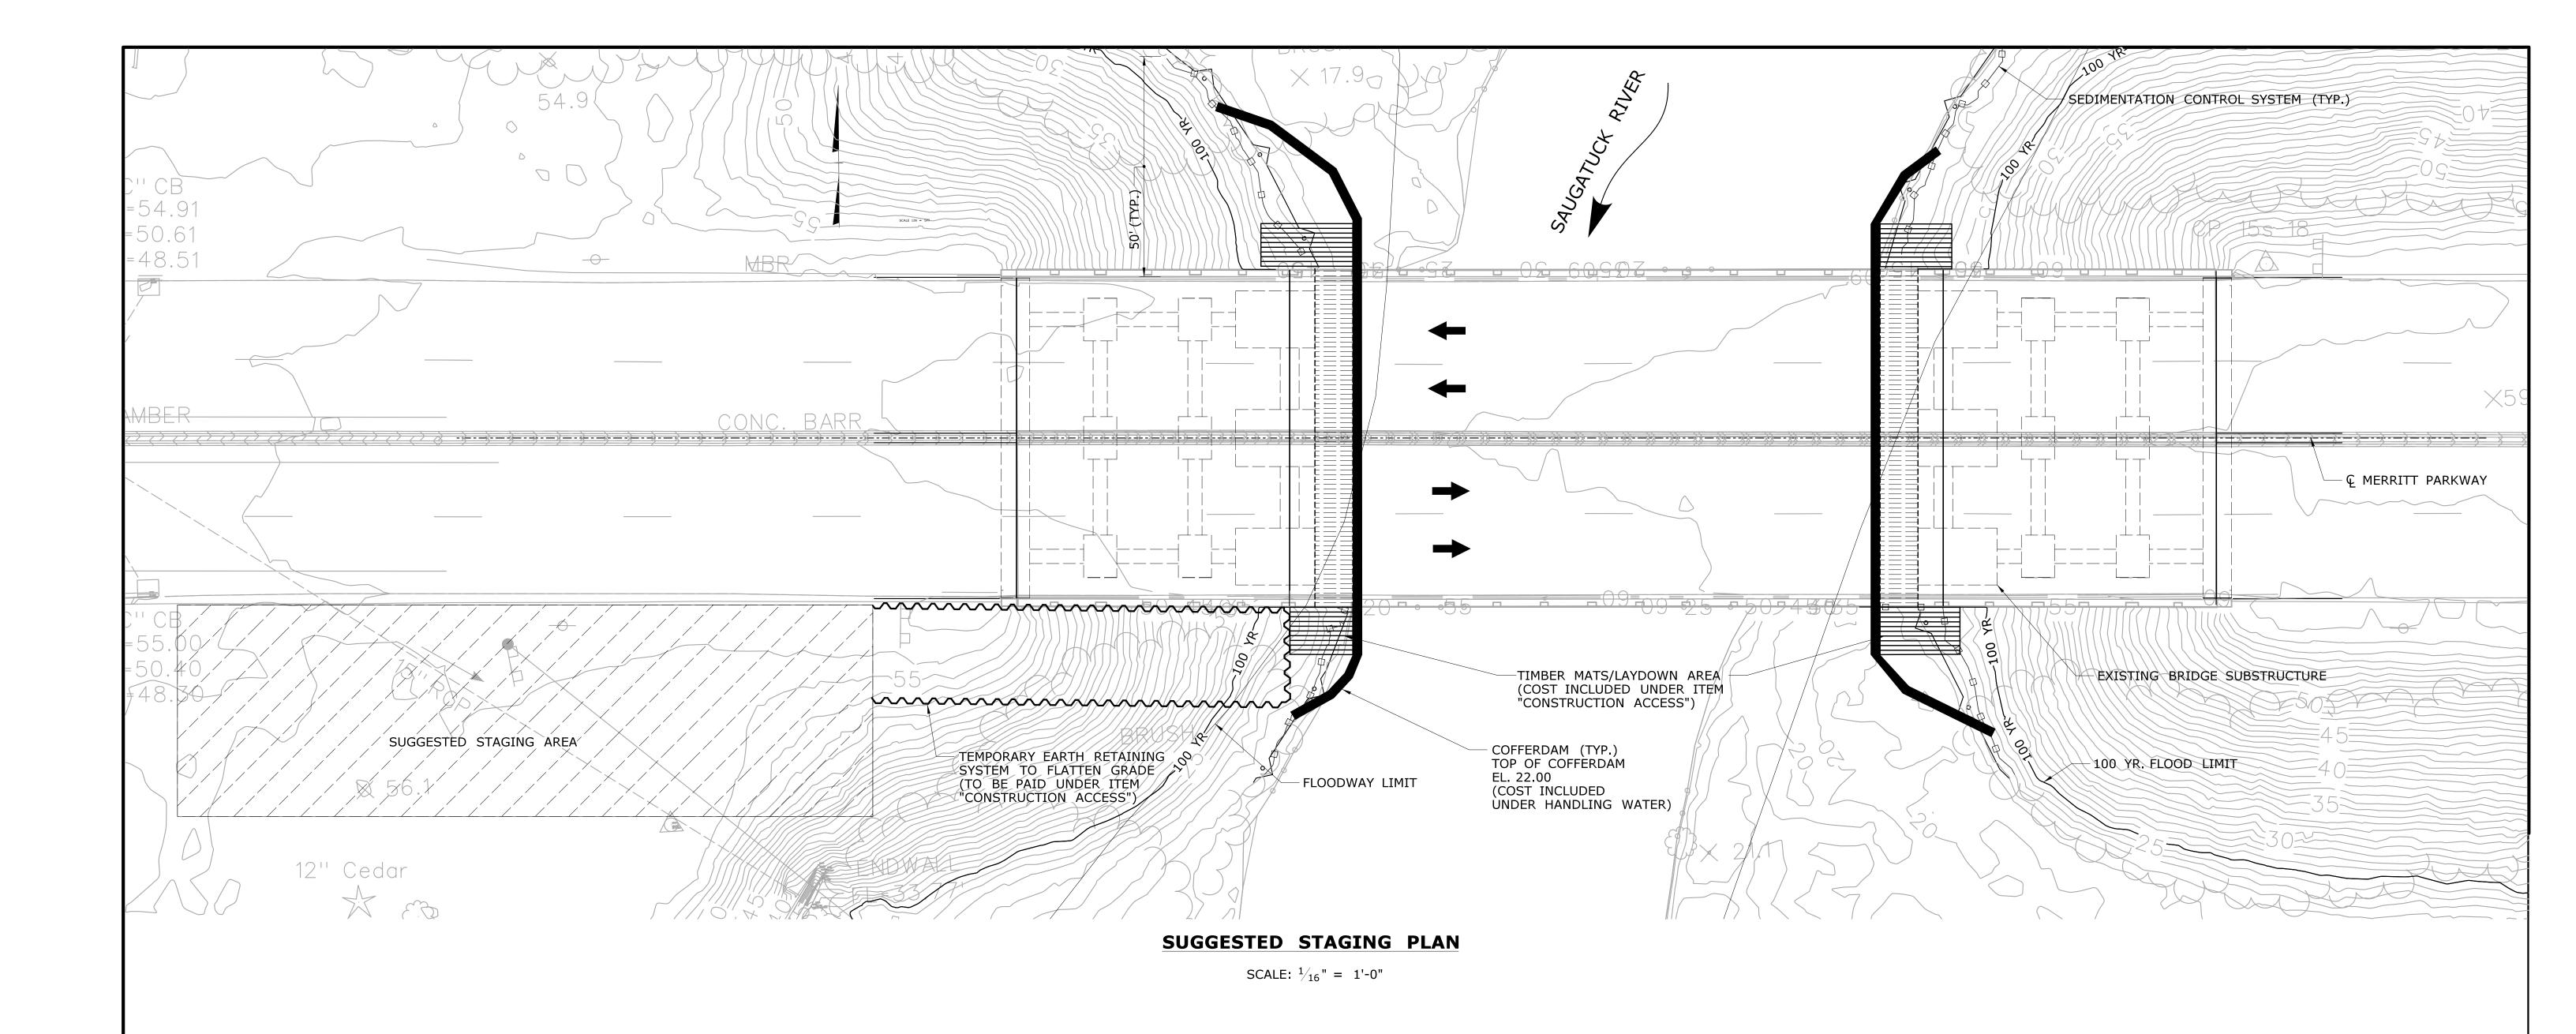

#### **STAGING PLAN NOTES:**

- 1. ALL SITE ACCESS PLANS SHOWN ON THE DRAWING ARE CONCEPTUAL. THE CONTRACTOR IS REQUIRED TO SUBMIT A DETAILED WORKING DRAWING SUBMISSION OUTLINING HIS SITE ACCESS PLAN IN ACCORDANCE WITH THE REQUIREMENTS IN THE SPECIAL PROVISION "CONSTRUCTION ACCESS".
- 2. DURING ALL CONSTRUCTION WORK, THE CONTRACTOR SHALL TAKE NECESSARY PRECAUTIONS TO ENSURE THAT ALL WORK AT THE SITE IS PERFORMED IN A SAFE MANNER.
- 3. ALL SITE WORK SHALL BE DONE IN ACCORDANCE WITH THE SPECIAL PROVISIONS "CONSTRUCTION ACCESS"
- 4. THE CONTRACTOR SHALL MAINTAIN SAFE ACCESS TO THE SITE FOR DELIVERIES AND ALL OTHER OPERATIONS INVOLVING TRAFFIC INTO AND OUT OF THE SITE.
- 5. THE CONTRACTOR SHALL HAVE A PLAN TO MAINTAIN ADEQUATE DRAINAGE AT THE SITE. DRAINAGE SHALL BE CHANNELED AWAY FROM THE SITE TO AN UNUSED LOCATION. SHEET FLOW DRAINAGE FROM MERRITT PARKWAY SHALL NOT BE IMPEDED AT ANY TIME.
- 6. FILLING IN OF WETLANDS OR OTHER WORK IN DESIGNATED WETLANDS, EXCEPT AS SHOWN HEREIN WILL NOT BE ALLOWED.
- 7. ONCE ALL CONSTRUCTION WORK IS COMPLETE, THE CONTRACTOR SHALL RESTORE THE SITE TO ORIGINAL CONDITIONS.
- 8. TRAFFIC CLOSURES ON MERRITT PARKWAY SHALL BE IN ACCORDANCE WITH THE MAINTENANCE AND PROTECTION OF TRAFFIC PLANS AND IN ACCORDANCE WITH THE SPECIAL PROVISIONS.

THE INFORMATION, INCLUDING ESTIMATED QUANTITIES OF WORK, SHOWN ON THESE	DESIGNER/DRAFTER:  NRA  CHECKED BY:	CONNECTICUE	SIGNATURE/ BLOCK:  BLO	GM2 ASSOCIATES, INC. 115 GLASTONBURY BLVD GLASTONBURY, CT 06033  PROJECT TITLE:  REHABILITATION OF BRIDGE 00728	WESTPORT	158-207
SHEETS IS BASED ON LIMITED INVESTIGATIONS BY THE STATE AND IS IN NO WAY WARRANTED TO INDICATE THE CONDITIONS OF ACTUAL QUANTITIES	JG	DEPARTMENT OF TRANSPORTATION	The control of the co	MERRITT PARKWAY	DRAWING TITLE:	- S-08
OF WORK WHICH WILL BE REQUIRED.	SCALE AS NOTED	DEPARTMENT OF TRANSPORTATION	SENSED THE		SUGGESTED STAGING & WATER HANDLING PLAN	SHEET NO. <b>05.03.08</b>


AREAS OF WETLAND IMPACTS


2000 S.F.

1556 S.F.

TEMPORARY

PERMANENT

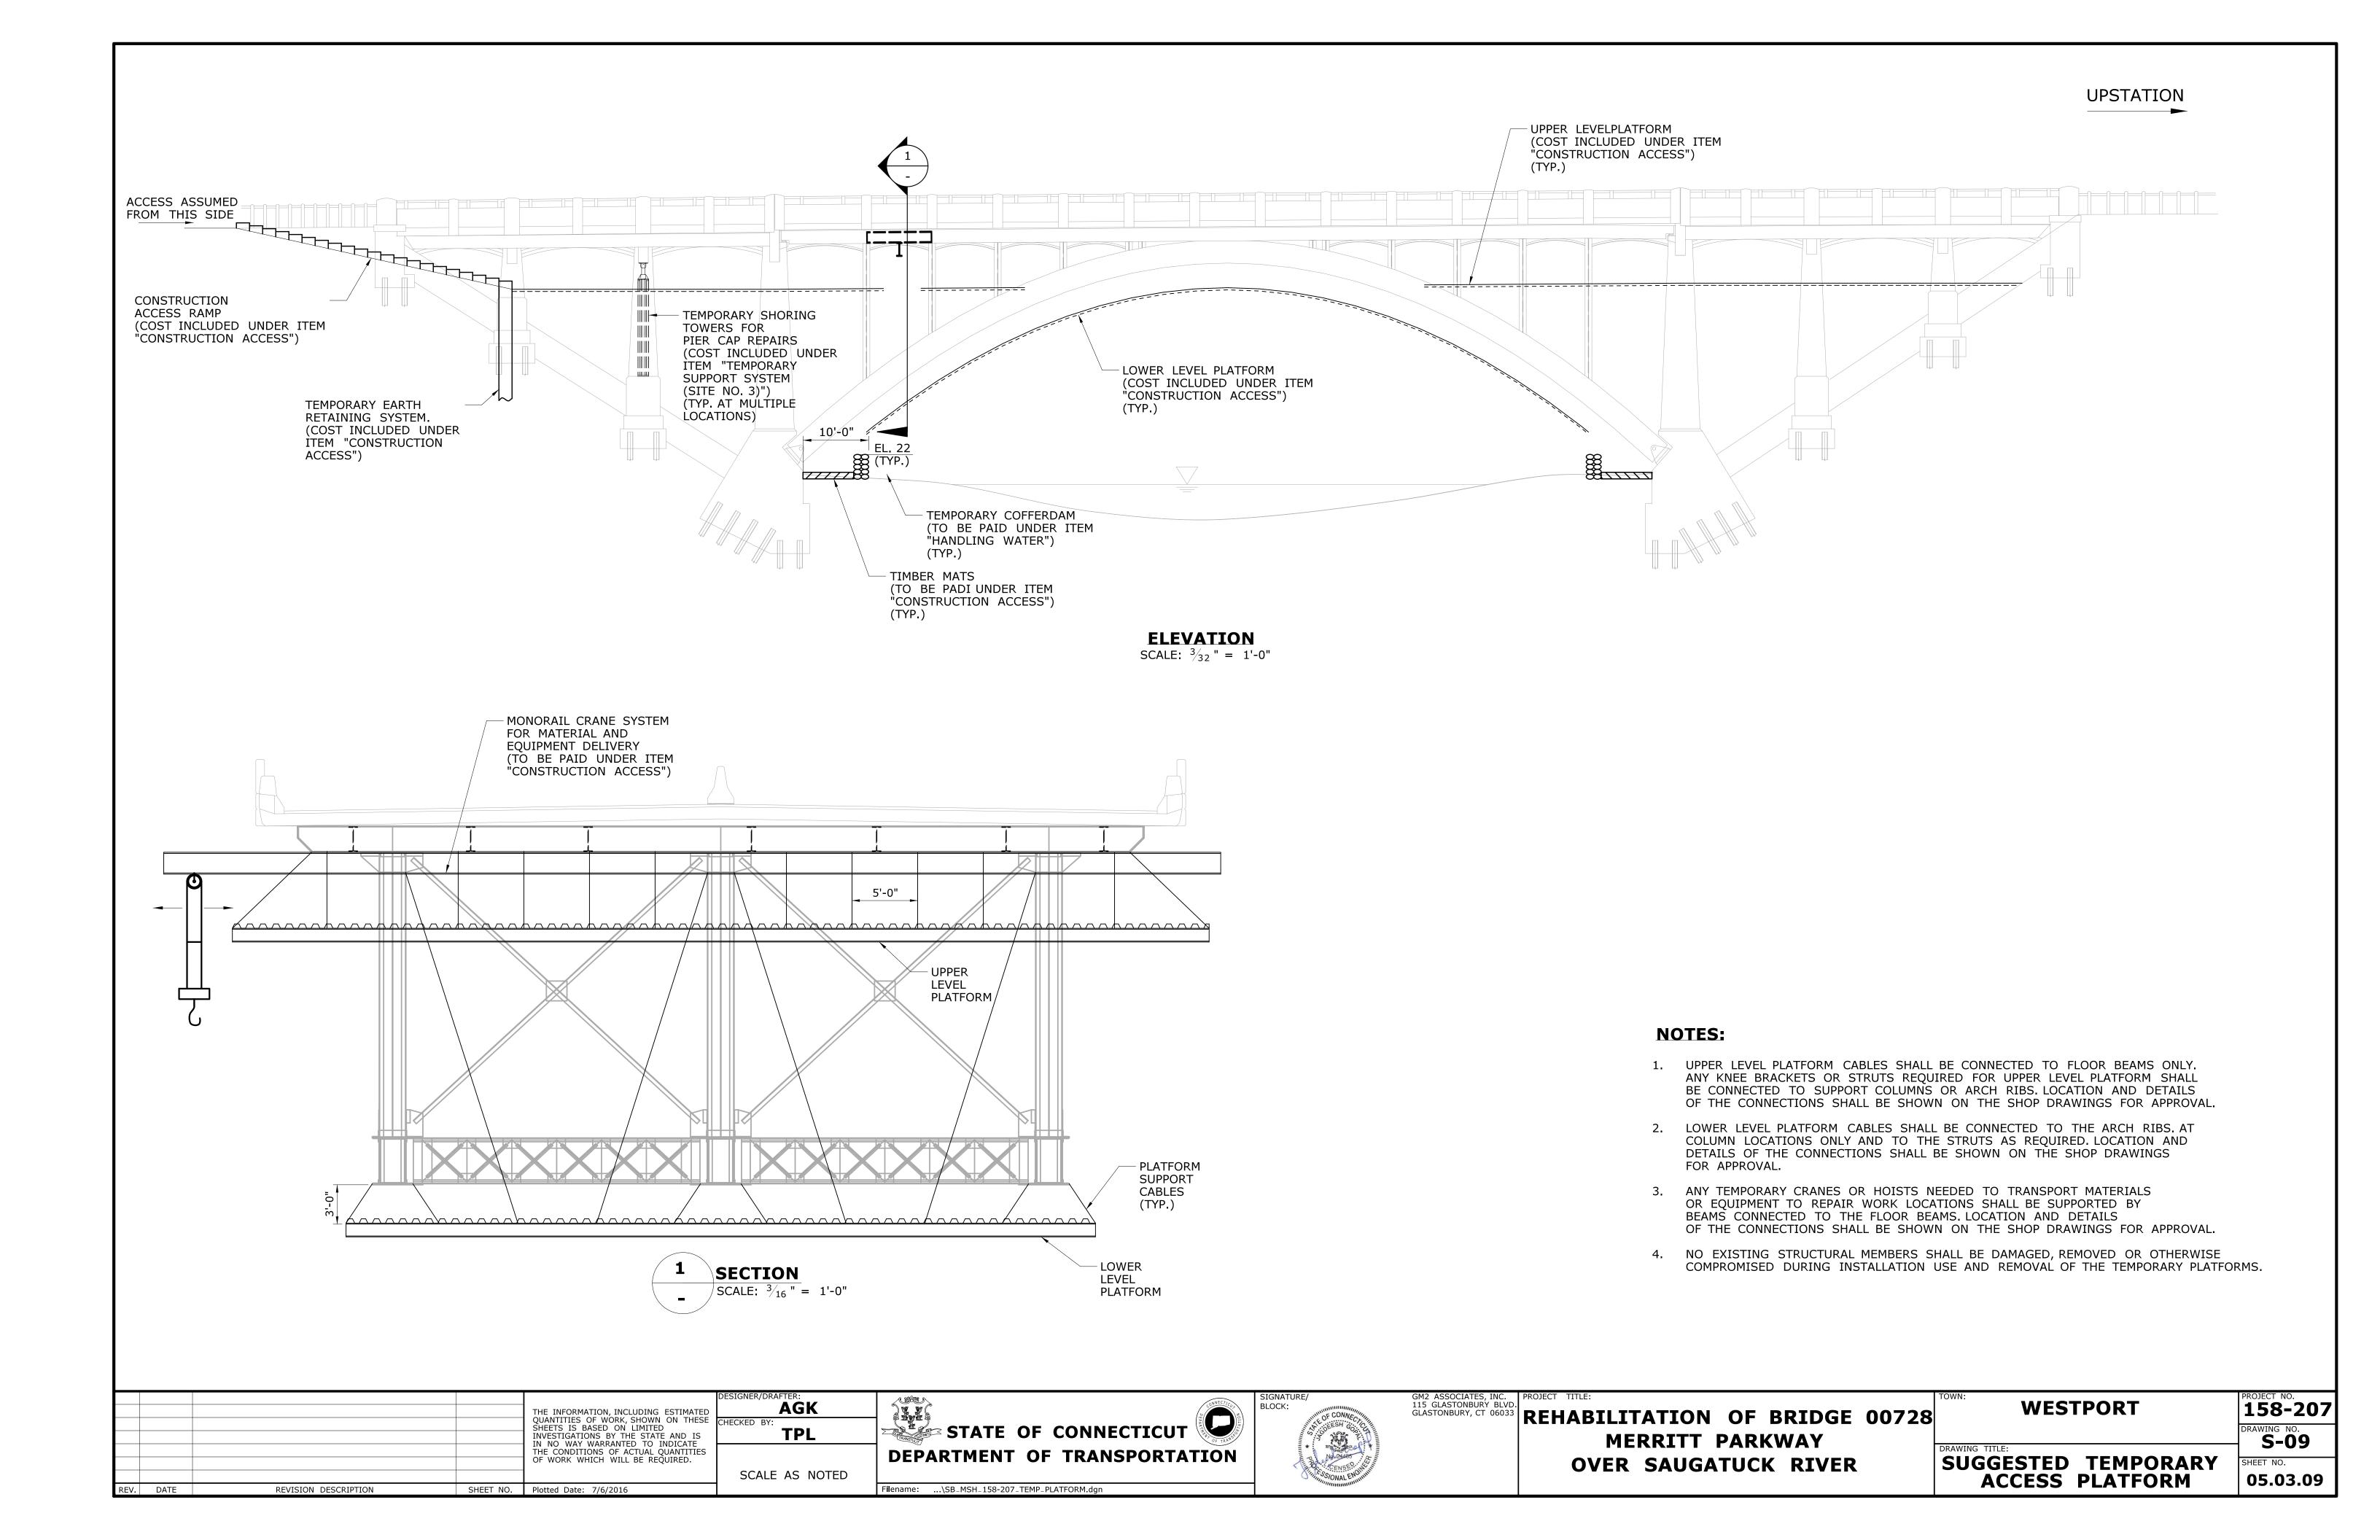

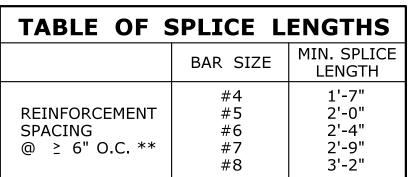

\*\* FOR BARS SPACED "LESS THAN" 6" O.C. MULTIPLY TABLE VALUES BY 1.25

#### **EXISTING REINFORCING-**SAWCUT TO A DEPTH OF $\frac{1}{2}$ " AT EDGES OF PATCH BLAST CLEAN EXPOSED REINFORCING BARS AND PAINT BARS WITH AN APPROVED CEMENTITIOUS PRIMER BEFORE PLACING PATCH MATERIAL. VOID AREA OF EXISTING PATCH WITH VARIABLE DEPTH PATCH. SCALE OR SPALL FINISH SMOOTH AND EVEN WITH ADJACENT CONCRETE. REMOVE DETERIORATED CONCRETE TO SOUND CONCRETE SOUND CONCRETE ADJACENT TO PATCH SOUND CONCRET

**CONCRETE REPAIR NOTES:** 

BY THE ENGINEER.

REINFORCING BAR REPAIRS

EMBEDDED GALVANIC ANODES

DIRECTED BY THE ENGINEER.

NOTIFIED IMMEDIATELY.

NOTIFIED IMMEDIATELY.

SAME TIME, THE ENGINEER SHALL BE CONSULTED.

**RESTRICTIONS** 

15 POUNDS.

ENGINEER.

PAY ITEM NOTES

APPLICABLE REPAIR PAY ITEM.

"DEFORMED STEEL BARS".

THE ENGINEER WILL DETERMINE THE LOCATIONS OF UNSOUND OR DETERIORATED

THE CONTRACTOR SHALL REMOVE THE DETERIORATED CONCRETE IN ACCORDANCE

THE ENGINEER WILL DETERMINE THE TYPE OF REPAIR REQUIRED FOR EACH AREA.

WITH THE GUIDELINES SET IN THESE NOTES AND IN THE SPECIAL PROVISIONS AND

THE CONTRACTOR SHALL SUPPLY WHATEVER MEANS NECESSARY, INCLUDING BUT NOT

LIMITED TO LADDERS, LIFTS AND TRAFFIC PROTECTION FOR THE ENGINEER TO SAFELY

ACCESS VARIOUS AREAS FOR INSPECTION. THE COST OF PROVIDING ACCESS FOR THE

VARIABLE DEPTH PATCH AND CLASS "S" CONCRETE FOR HISTORIC BRIDGES REPAIR DETAILS

THESE DETAILS ARE INCLUDED FOR REFERENCE ONLY AND SHALL BE USED ONLY AS DIRECTED

ARE APPLICABLE TO VERTICAL CONCRETE SURFACES AND NOT TOP OF DECK OR HEADERS.

PARTIAL DEPTH PATCH AND FULL DEPTH PATCH DETAILS SHOWN IN DRAWING S-23 SHALL

AFTER REMOVAL, OR REQUIRE HARSH CHEMICALS TO REMOVE.

INSPECTION IS INCLUDED IN THE GENERAL COST OF THE PROJECT.

BE USED FOR ALL DECK AND CONCRETE HEADER REPAIRS.

CLASS "S" CONCRETE FOR HISTORIC BRIDGES (CLASS "S" TYPE)

THIS TYPE OF REPAIR SHALL BE USED WHERE THE REINFORCING BARS

MATERIAL. IF THERE IS NOT SUFFICIENT REINFORCEMENT AVAILABLE, THEN

FOR SMALLER AREAS LESS THAN FOUR SQUARE FEET WHERE THERE IS A

SUFFICIENT TOTAL AREA TO JUSTIFY THE USE OF THIS MATERIAL AND

BE BLAST CLEANED AND EMBEDDED GALVANIC ANODES INSTALLED.

LENGTH SPECIFIED IN THE TABLE ON THIS SHEET.

THAT CROSS THE EDGES OF THE PATCH.

WHERE THE PATCH CAN BE SECURELY ANCHORED BY THE REINFORCING.

SHALL BE INSTALLED INTO THE SOUND CONCRETE TO ENGAGE THE WELDED WIRE FABRIC. CLASS "S" CONCRETE FOR HISTORIC BRIDGES MAY BE USED

GALVANIZED MECHANICAL ANCHORS @ 6" O.C. (OR AS DIRECTED BY THE ENGINEER)

OVERHEAD PATCHES SHALL BE A CLASS "S" TYPE UNLESS OTHERWISE DIRECTED BY

THE ENGINEER AND SHALL BE ANCHORED SECURELY TO THE REINFORCING BARS.

BEFORE APPLYING THE PATCHING MATERIAL, THE REINFORCING BARS SHALL

REINFORCING WHICH IS DETERMINED BY THE ENGINEER TO BE IN NEED OF

REPLACEMENT, SHALL BE REMOVED TO A POINT WHERE IT IS SOUND. THE PATCH

ANODES ARE TO BE INSTALLED IN "CLASS 'S' CONCRETE FOR HISTORIC BRIDGES" CONCRETE REPAIRS. THEIR PRIME PURPOSE IS TO PROTECT REINFORCING BARS

INSTALLATION OF ANODES SHALL BE AS DETAILED ON THIS PLAN AND PER THE

RECOMMENDATIONS OF THE ANODE MANUFACTURER'S REPRESENTATIVE AND AS

THE REMOVAL OF DETERIORATED CONCRETE SHALL PROCEED AS DIRECTED BY

MAXIMUM HAMMER SIZE USED TO REMOVE DETERIORATED CONCRETE SHALL BE

IF REMOVAL EXTENDS MORE THAN  $1\frac{1}{2}$ " BEHIND THE MAIN REINFORCING BARS,

SHALL BE IMMEDIATELY NOTIFIED BEFORE CONTINUING REMOVAL WORK.

ONE THIRD OF THE SPAN. THE MIDDLE THIRD SHOULD BE PATCHED LAST.

THE ENGINEER. IF THE REMOVAL OF DETERIORATED CONCRETE BECOMES EXCESSIVE, THE REMOVAL WORK SHALL BE STOPPED AT THAT LOCATION AND THE ENGINEER

THE REMOVAL WORK SHALL BE STOPPED AND THE ENGINEER NOTIFIED IMMEDIATELY.

IF THE AREA OR DEPTH OF REMOVAL IS DEEMED TO BE EXCESSIVE, THE ENGINEER

AT PIER COLUMNS AND CAPS, IF REMOVAL OF DETERIORATED CONCRETE EXTENDS INSIDE THE MAIN REINFORCING, REMOVAL SHALL BE LIMITED TO ONE FACE OF THE MEMBER AT

OR DIRECTLY OPPOSITE ONE ANOTHER. IF REMOVAL EXTENDS MORE THAN  $1\frac{1}{2}$ " BEHIND

A TIME AND A MAXIMUM AREA OF 4 S.F. REMOVAL MAY BE PERMITTED ON MORE THAN ONE FACE OF THE COLUMN SIMULTANEOUSLY IF THE AREAS OF REMOVAL ARE NOT ADJACENT TO

THE MAIN REINFORCING BARS, THE REMOVAL WORK SHALL BE STOPPED AND THE ENGINEER

BEFORE EXPOSING THE MAIN REINFORCING BARS OF MORE THAN ONE PIER COLUMN AT THE

AT THE PIER CAP, NO MORE THAN ONE THIRD OF THE UNDERSIDE OF THE CAP SHOULD BE

REMOVED AT ONE TIME. IF THE ENTIRE UNDERSIDE OF THE CAP IS TO BE PATCHED, BEGIN

HAS GAINED SUFFICIENT STRENGTH, BEGIN AT THE OPPOSITE END OF THE CAP AND PATCH

IF A SPLICE IS ENCOUNTERED DURING REMOVAL OF CONCRETE IN A PIER COLUMN OR CAP,

WORK AT THAT LOCATION SHALL BE STOPPED AND THE ENGINEER SHALL BE NOTIFIED.

WORK AT THAT LOCATION SHALL NOT PROCEED UNTIL DIRECTION IS GIVEN BY THE

1. ANODES SHALL BE PAID FOR UNDER THE ITEM "EMBEDDED GALVANIC ANODES".

3. REINFORCING BARS WILL BE PAID FOR AT THE CONTRACT UNIT PRICE FOR

2. THE  $\frac{1}{2}$ " DEEP SAW CUT SHALL BE INCLUDED IN THE CONTRACT BID PRICE OF THE

AT THE COLUMN AND PATCH ONE-THIRD OF THE CLEAR SPAN OF THE CAP. AFTER THE PATCH

SHALL EXTEND A SUFFICIENT DISTANCE BEYOND THIS POINT TO DEVELOP A SPLICE


ARE SUFFICENTLY EXPOSED TO ENGAGE AND ANCHOR THE PATCHING

CONCRETE TO BE REPAIRED. THE METHOD USED TO DELINEATE AREAS OF CONCRETE

TO BE REPAIRED SHALL NOT PERMANENTLY MARK THE CONCRETE, LEAVE ANY RESIDUE

#### VARIABLE DEPTH PATCH FOR HISTORIC BRIDGES TYPE REPAIRS (REINFORCING PARTIALLY EXPOSED)

NOT TO SCALE

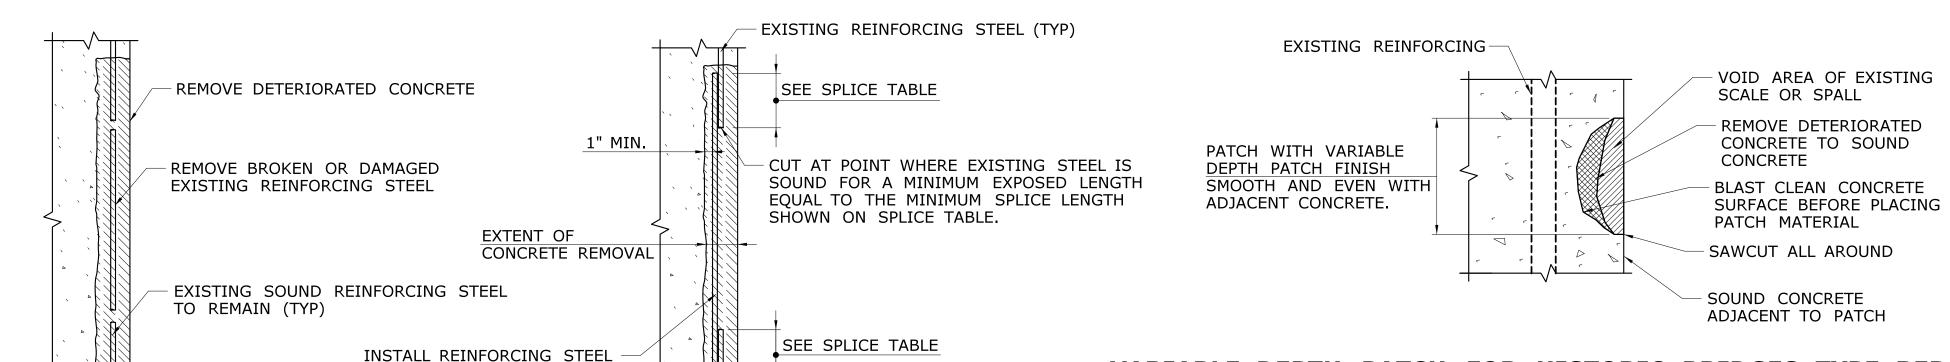

SAWCUT EDGE

TYPICAL SPLICE DETAIL

OF PATCH (TYP)

### VARIABLE DEPTH PATCH FOR HISTORIC BRIDGES TYPE REPAIRS (NO REINFORCING EXPOSED)

NOT TO SCALE

### REINFORCING REPAIR DETAIL

(SIZE AND SPACING TO

MATCH EXISTING STEEL)


SAWCUT EDGE

OF PATCH (TYP)

TYPICAL SECTION


DAMAGED REINFORCING

NOT TO SCALE

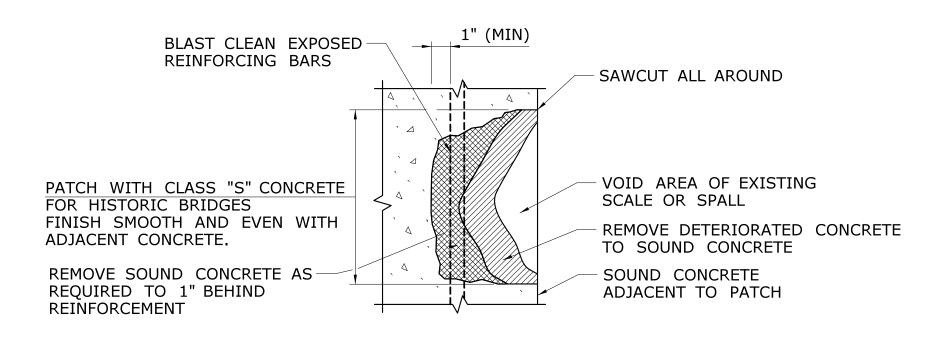

#### CLASS "S" CONCRETE FOR HISTORIC BRIDGES REPAIR

NOT TO SCALE

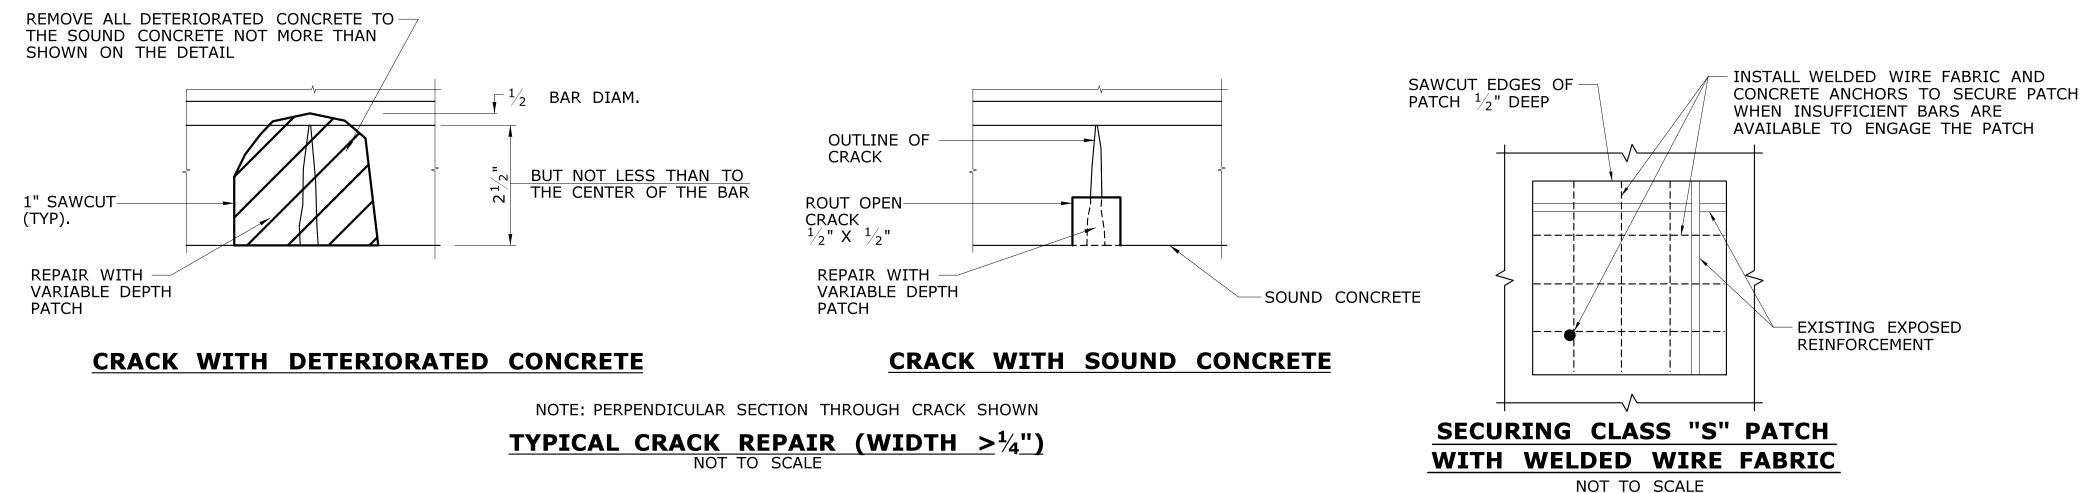


# BLOCK:

115 GLASTONBURY BLV


#### **WESTPORT** 158-207 AB THE INFORMATION, INCLUDING ESTIMATED GLASTONBURY, CT 06033 QUANTITIES OF WORK, SHOWN ON THESE SHEETS IS BASED ON LIMITED STATE OF CONNECTICUT REHABILITATION OF BRIDGE 00728 JG MERRITT PARKWAY INVESTIGATIONS BY THE STATE AND IS **S-10** NO WAY WARRANTED TO INDICATE THE CONDITIONS OF ACTUAL QUANTITIES OF WORK WHICH WILL BE REQUIRED. DEPARTMENT OF TRANSPORTATION **OVER SAUGATUCK RIVER CONCRETE REPAIR** HEET NO. SCALE AS NOTED 05.03.10 **DETAILS (1 OF 2)** Filename: ...\SB\_MSH\_158-207\_CONCRETE\_REP\_1..dan REVISION DESCRIPTION SHEET NO. Plotted Date: 7/6/2016 EV. DATE

#### **EMBEDDED GALVANIC ANODE NOTES**


- 1. ANODES ARE TO BE INSTALLED IN "PARTIAL DEPTH PATCH" AND "FULL DEPTH PATCH (EARLY HIGH STRENGTH CONCRETE)" REPAIRS AND IN CURB RECONSTRUCTION. THEIR PRIME PURPOSE IS TO PROTECT REINFORCING BARS BEYOND THE EDGES OF THE PATCH OR THE CONCRETE REMOVAL LIMITS.
- 2. INSTALLATION OF ANODES SHALL BE AS DETAILED ON THIS PLAN AND PER THE RECOMMENDATIONS OF THE ANODE MANUFACTURER'S REPRESENTATIVE AND AS DIRECTED BY THE ENGINEER.
- 3. PLACE ANODES SUCH THAT THEY HAVE 2" CONCRETE COVER.

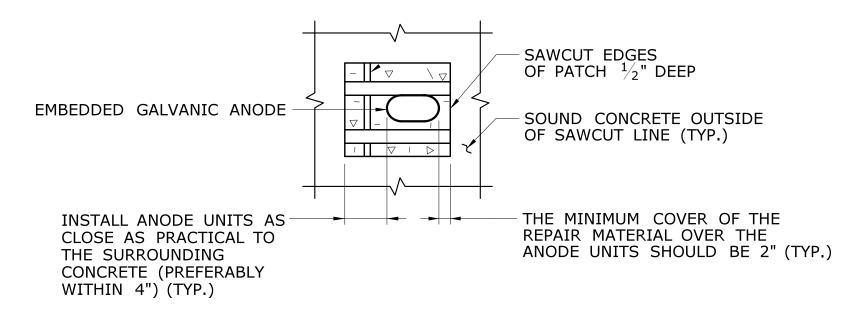

ANODE PLACEMENT - SMALL PATCH

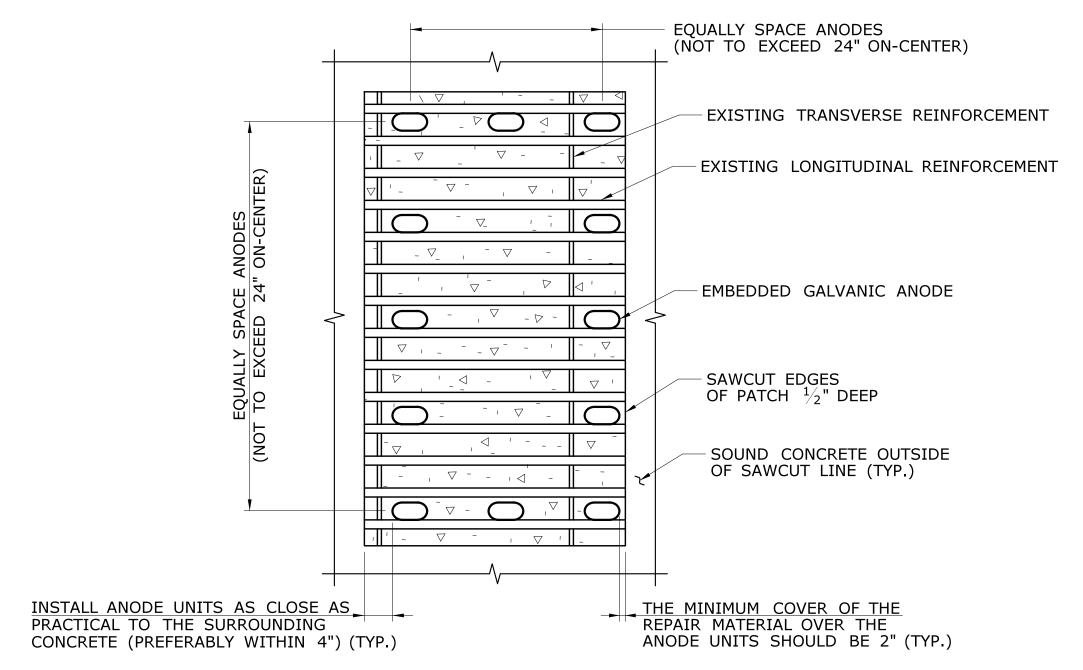

#### ANODE PLACEMENT - LARGE RECTANGULAR-TYPE PATCH

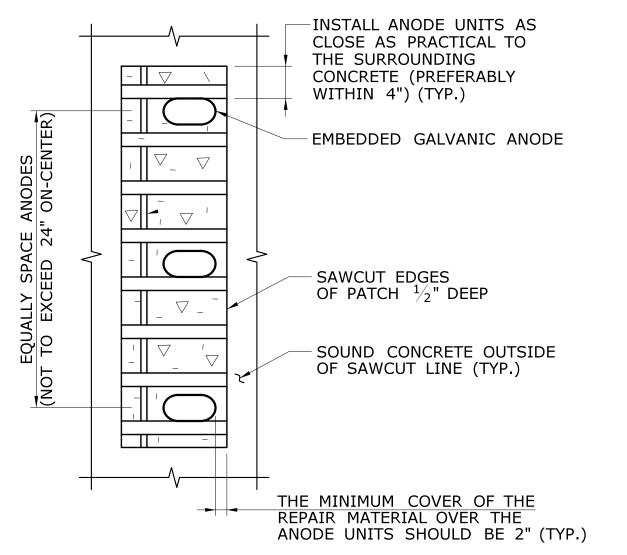

#### **ANODE PLACEMENT - NARROW-TYPE PATCH**

## INSTALLATION OF EMBEDDED GALVANIC ANODES


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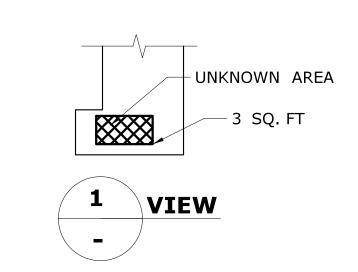
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REV. DATE REVISION DESCRIPTION SHEET NO. Plotted Date: 7/6/2016	SCALE AS NOTED	Filename:\SB_MSH_158-207_CONCRETE_REP_2.dgn	SENSE SONAL ENORMINE	OVER SAUGATUCK RIVER	CONCRETE REPAIR DETAILS (2 OF 2)	05.03.11


# LEGEND OF ANTICIPATED CONCRETE REPAIRS

VARIABLE DEPTH PATCH FOR HISTORIC CONCRETE BRIDGES

PATCH WITH CLASS "S" CONCRETE FOR HISTORIC BRIDGES



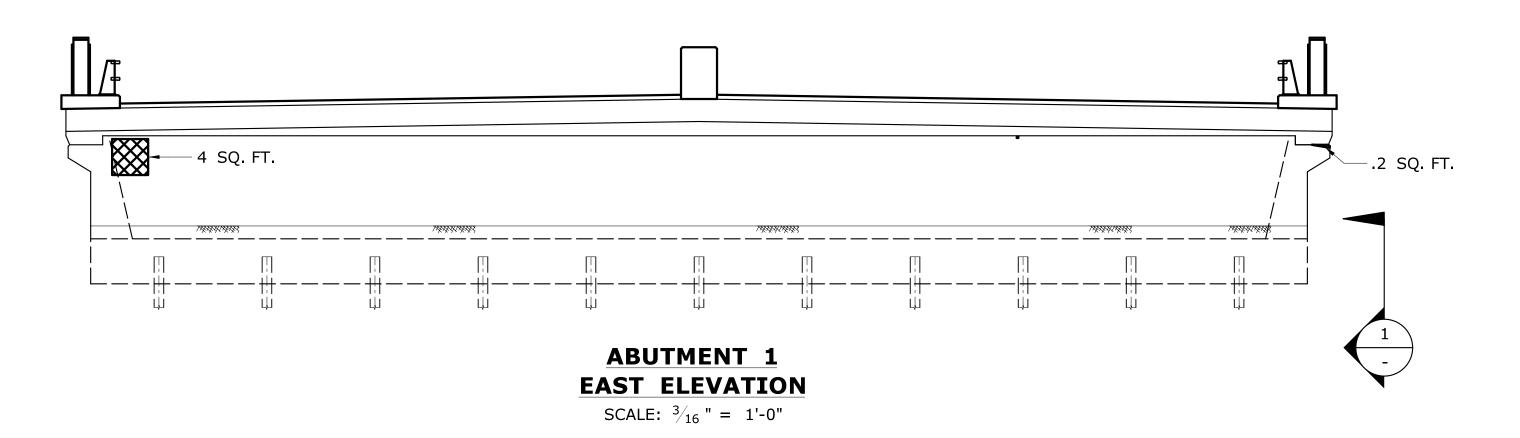


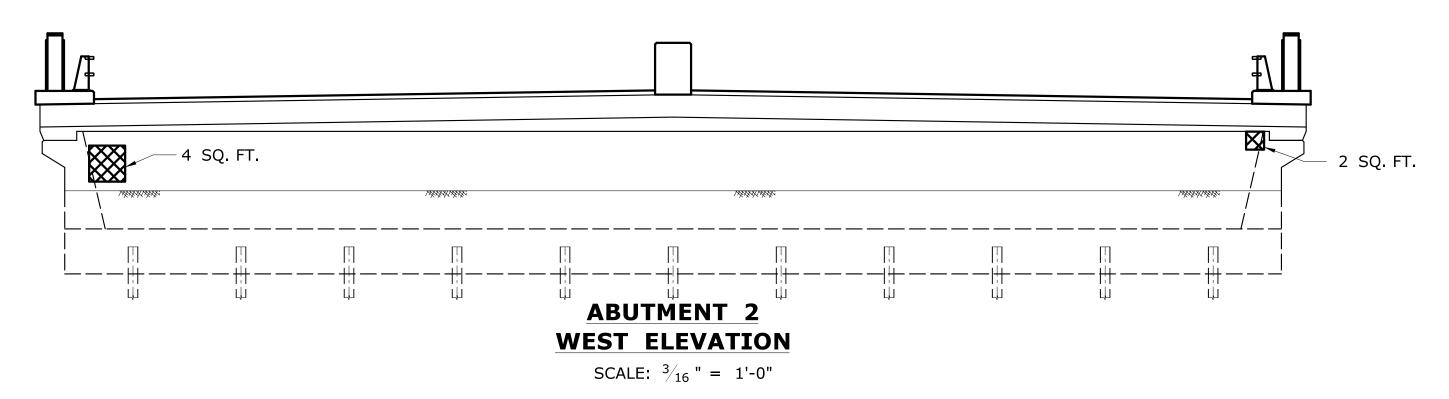

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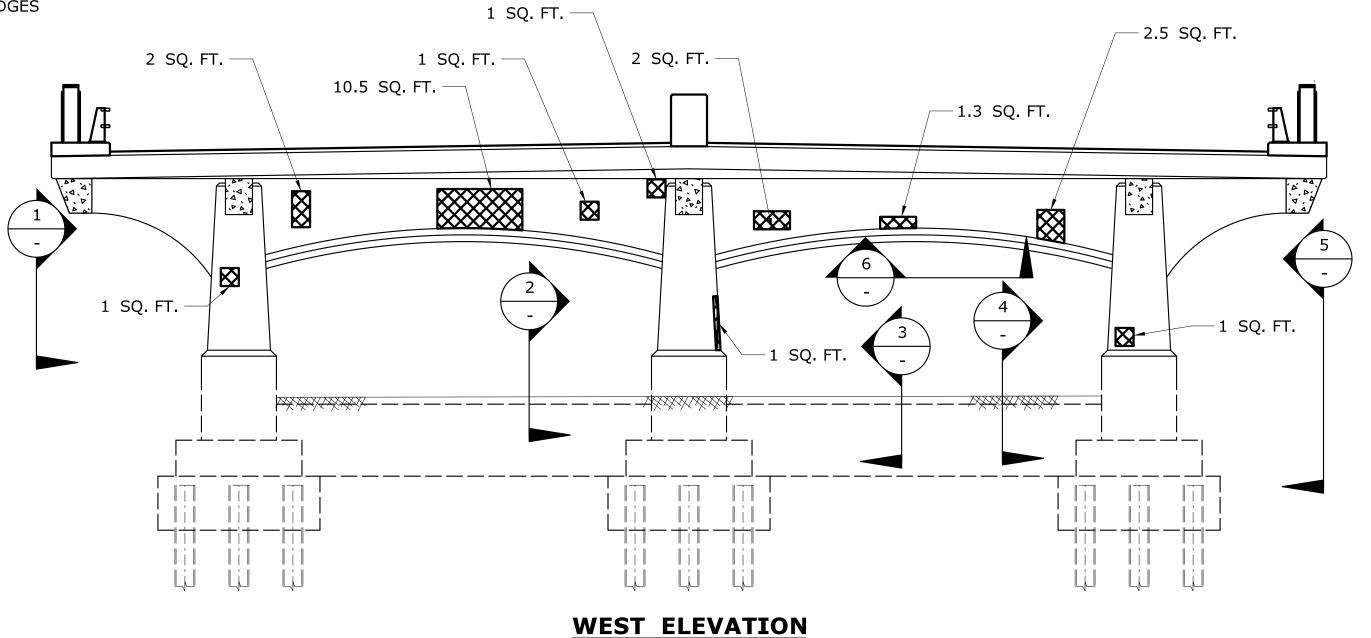
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EHABILITATION OF BRIDGE 00728						
MERRITT PARKWAY						
OVER SAUGATUCK RIVER						

WESTPORT	PROJECT NO. <b>158-207</b>
RAWING TITLE:	DRAWING NO.  S-12
ABUTMENT 1 AND 2 REPAIRS	SHEET NO. <b>05.03.12</b>

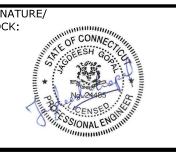



- VARIABLE DEPTH PATCH FOR HISTORIC CONCRETE BRIDGES
- PATCH WITH CLASS "S" CONCRETE FOR HISTORIC BRIDGES




PIER 1

SCALE:  $\frac{3}{16}$ " = 1'-0"

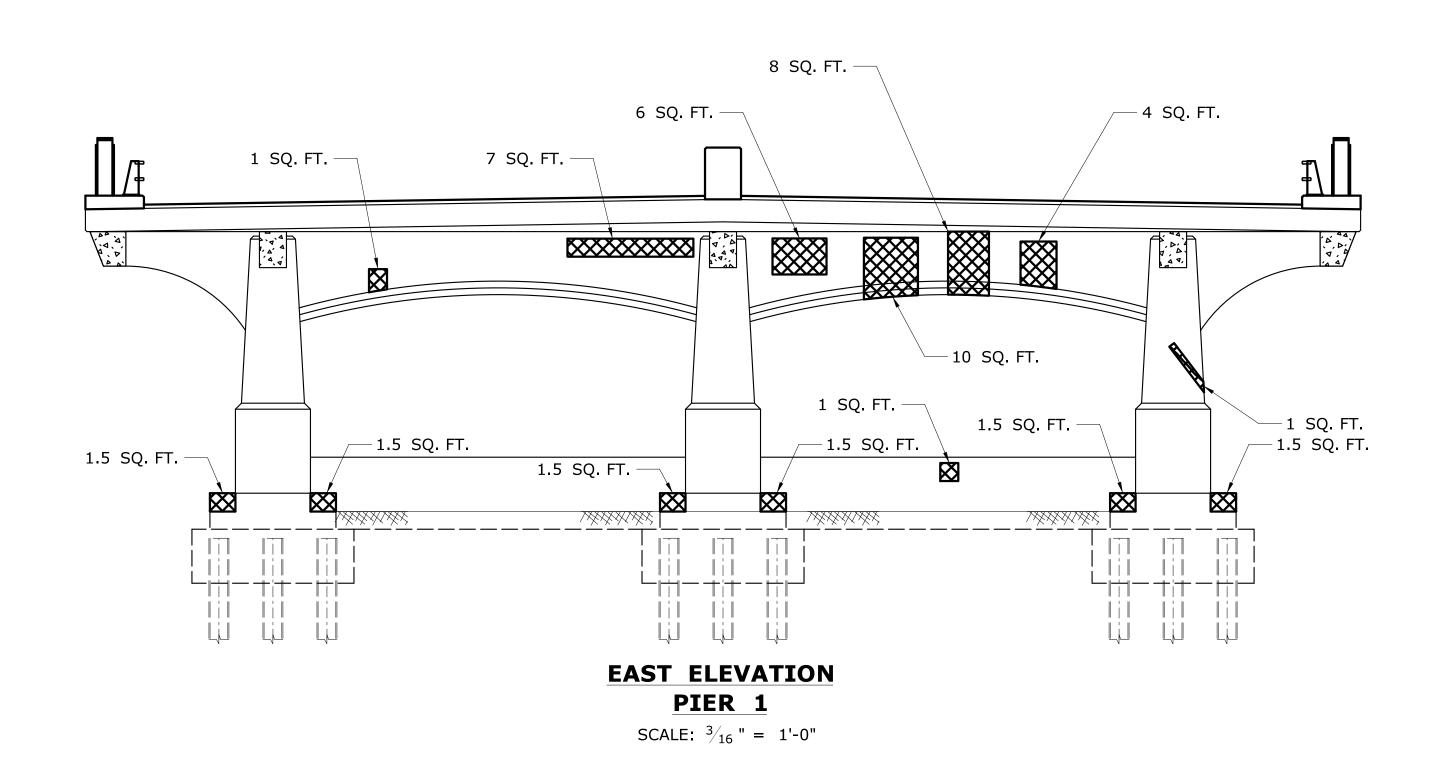


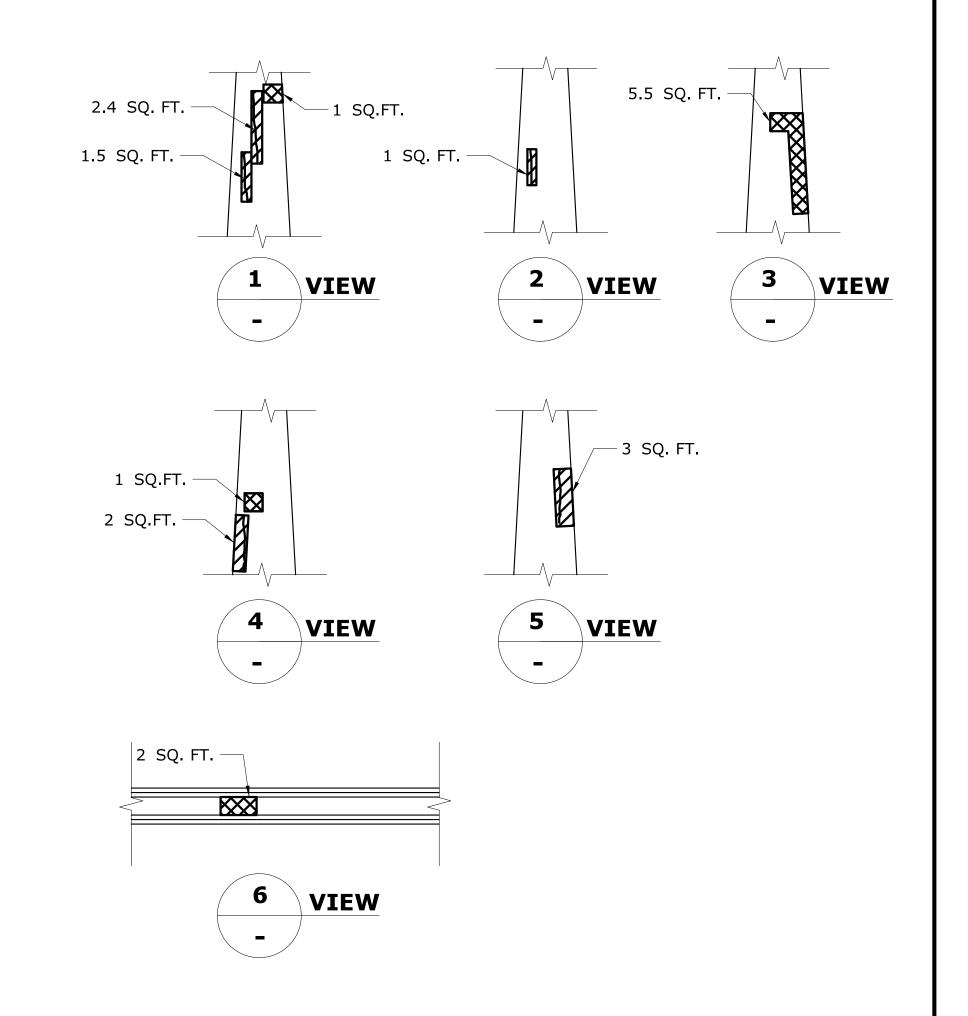

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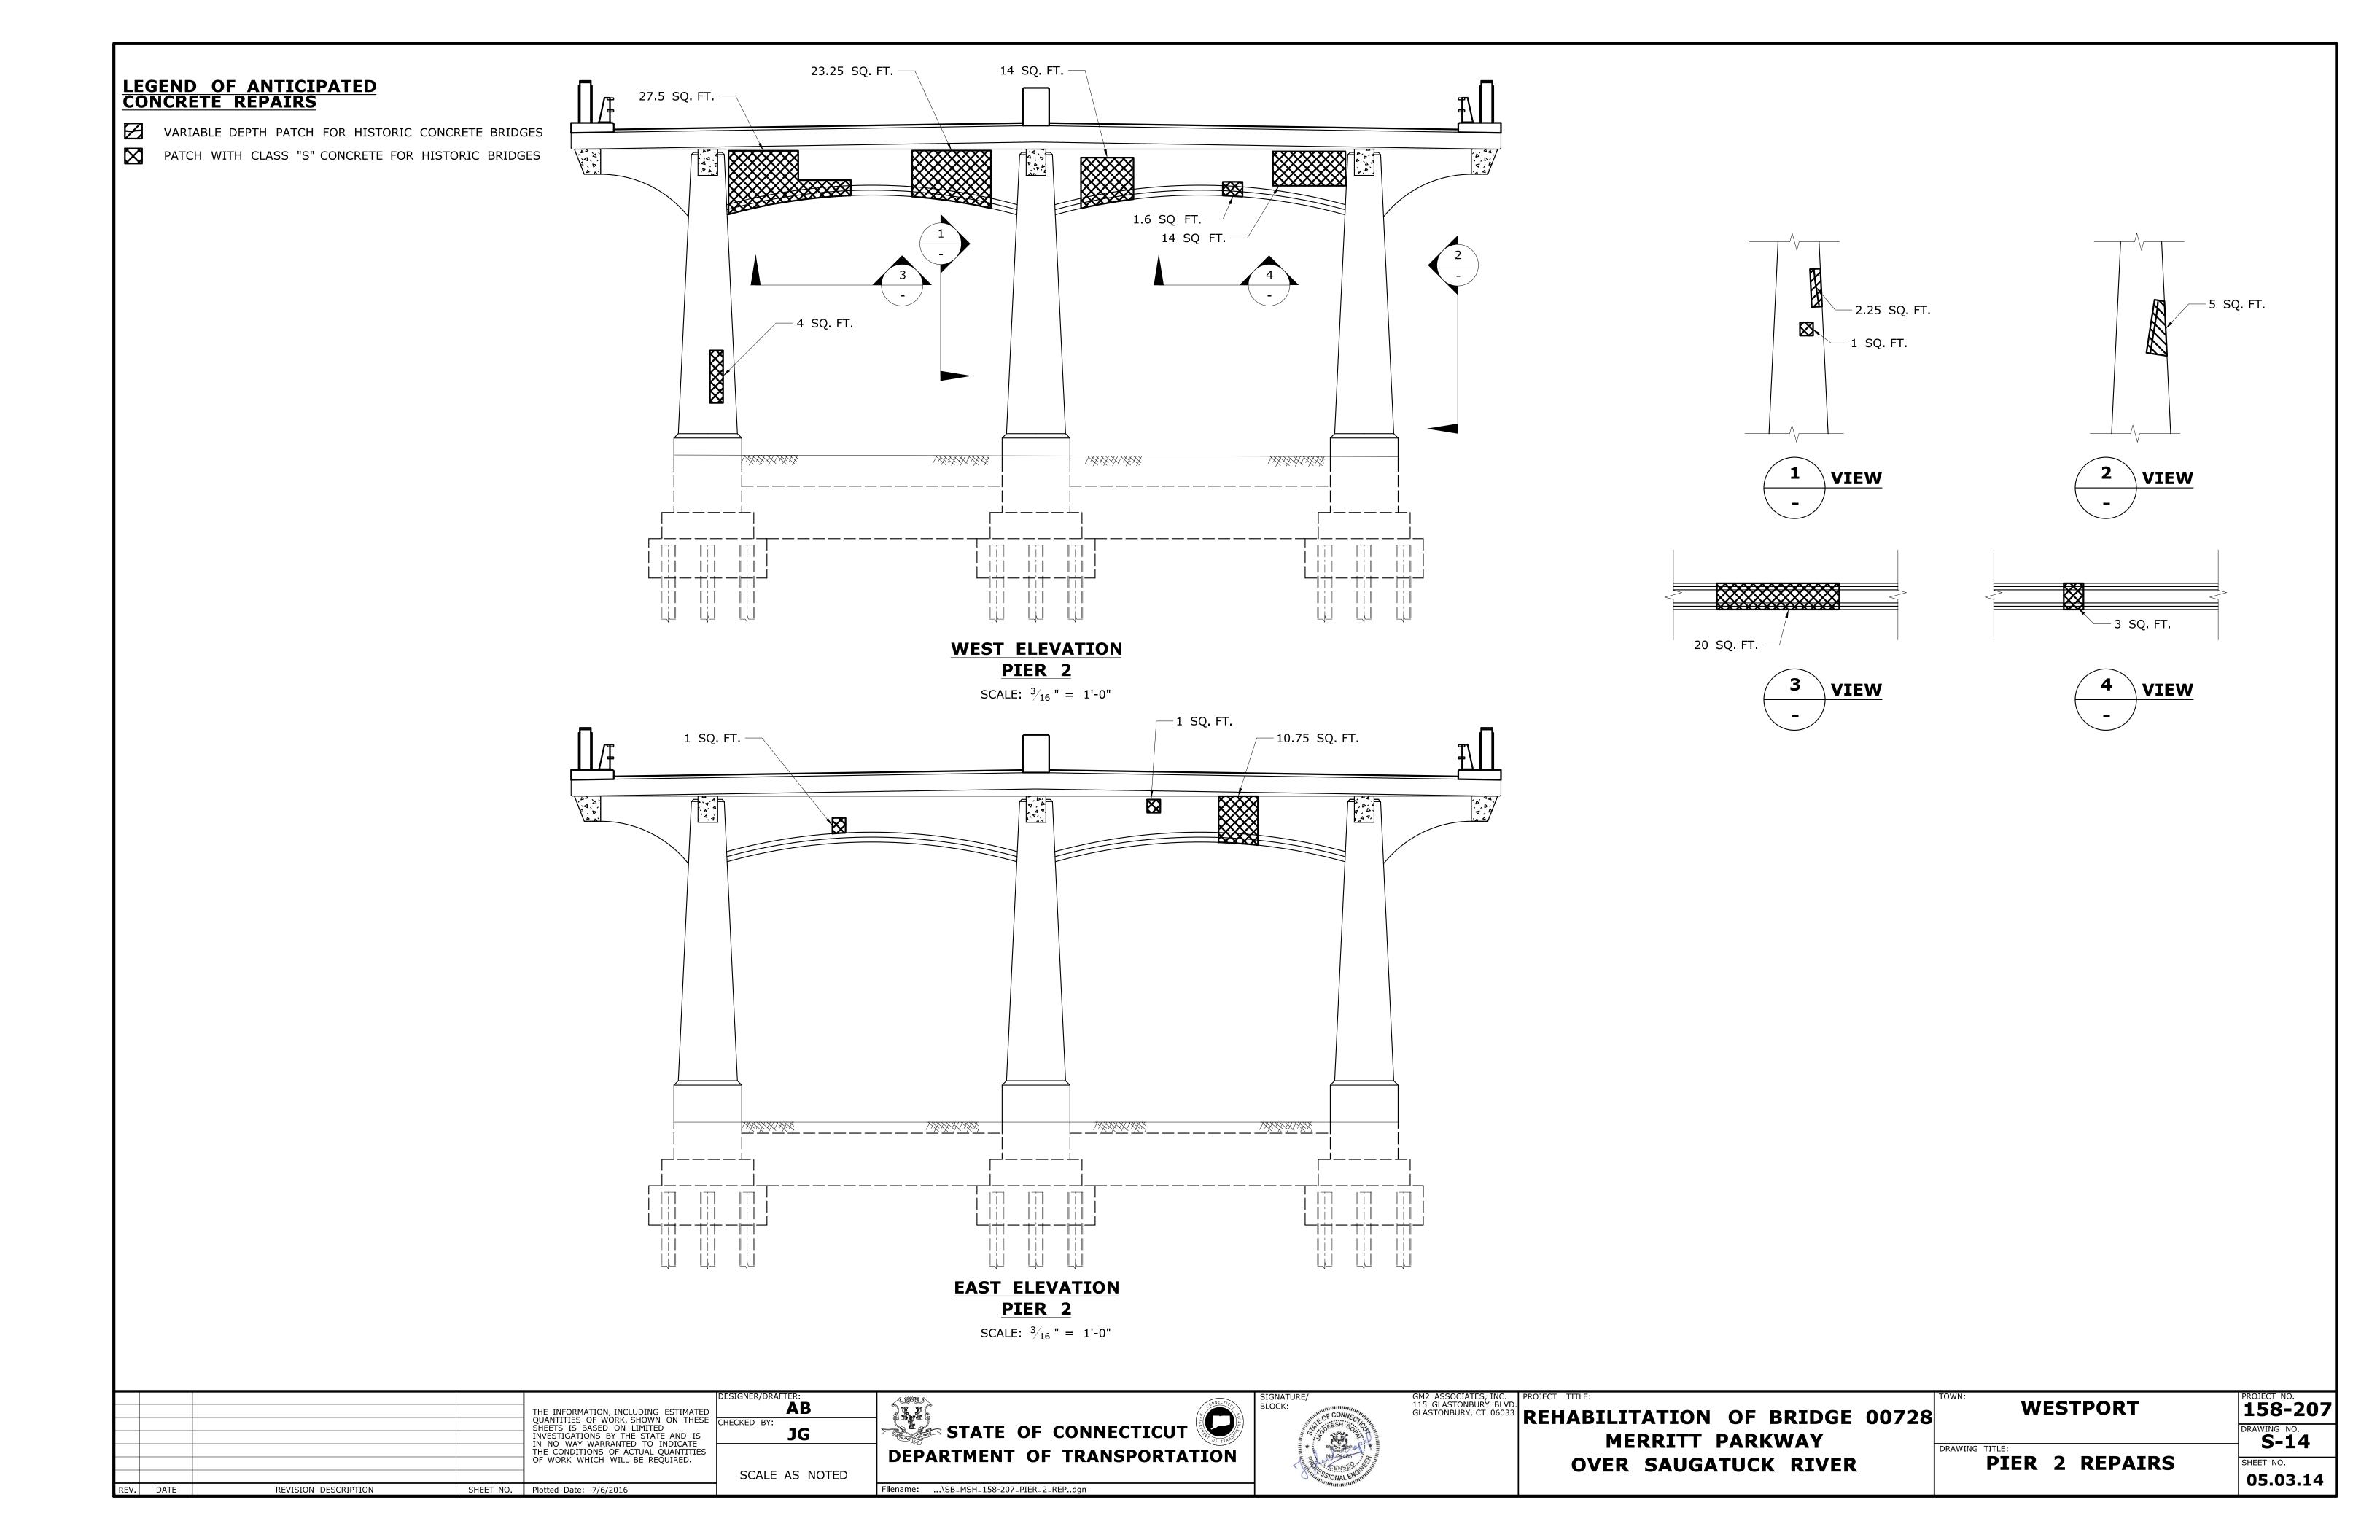


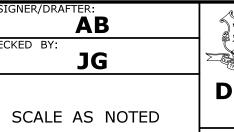



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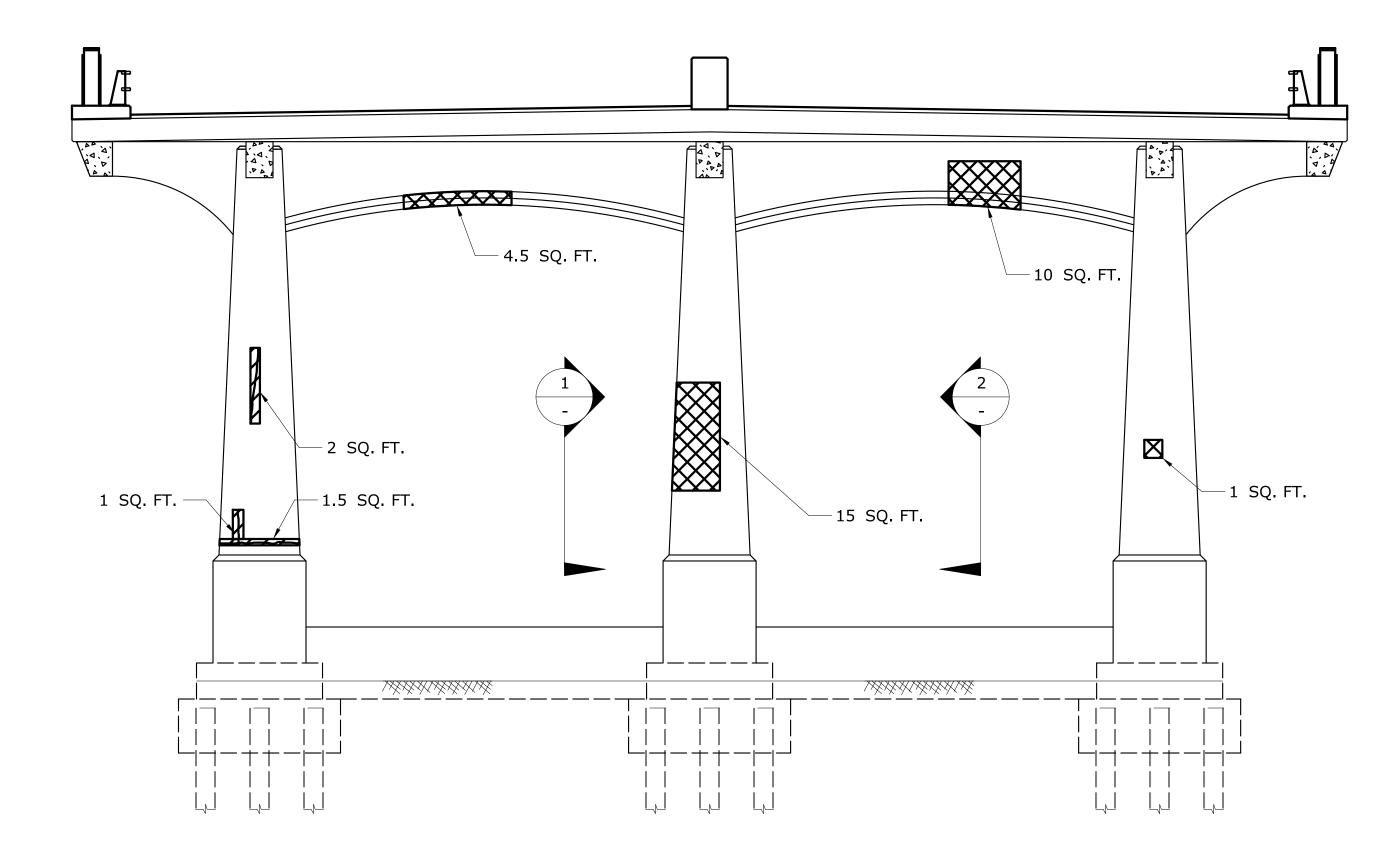


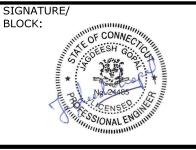




VARIABLE DEPTH PATCH FOR HISTORIC CONCRETE BRIDGES

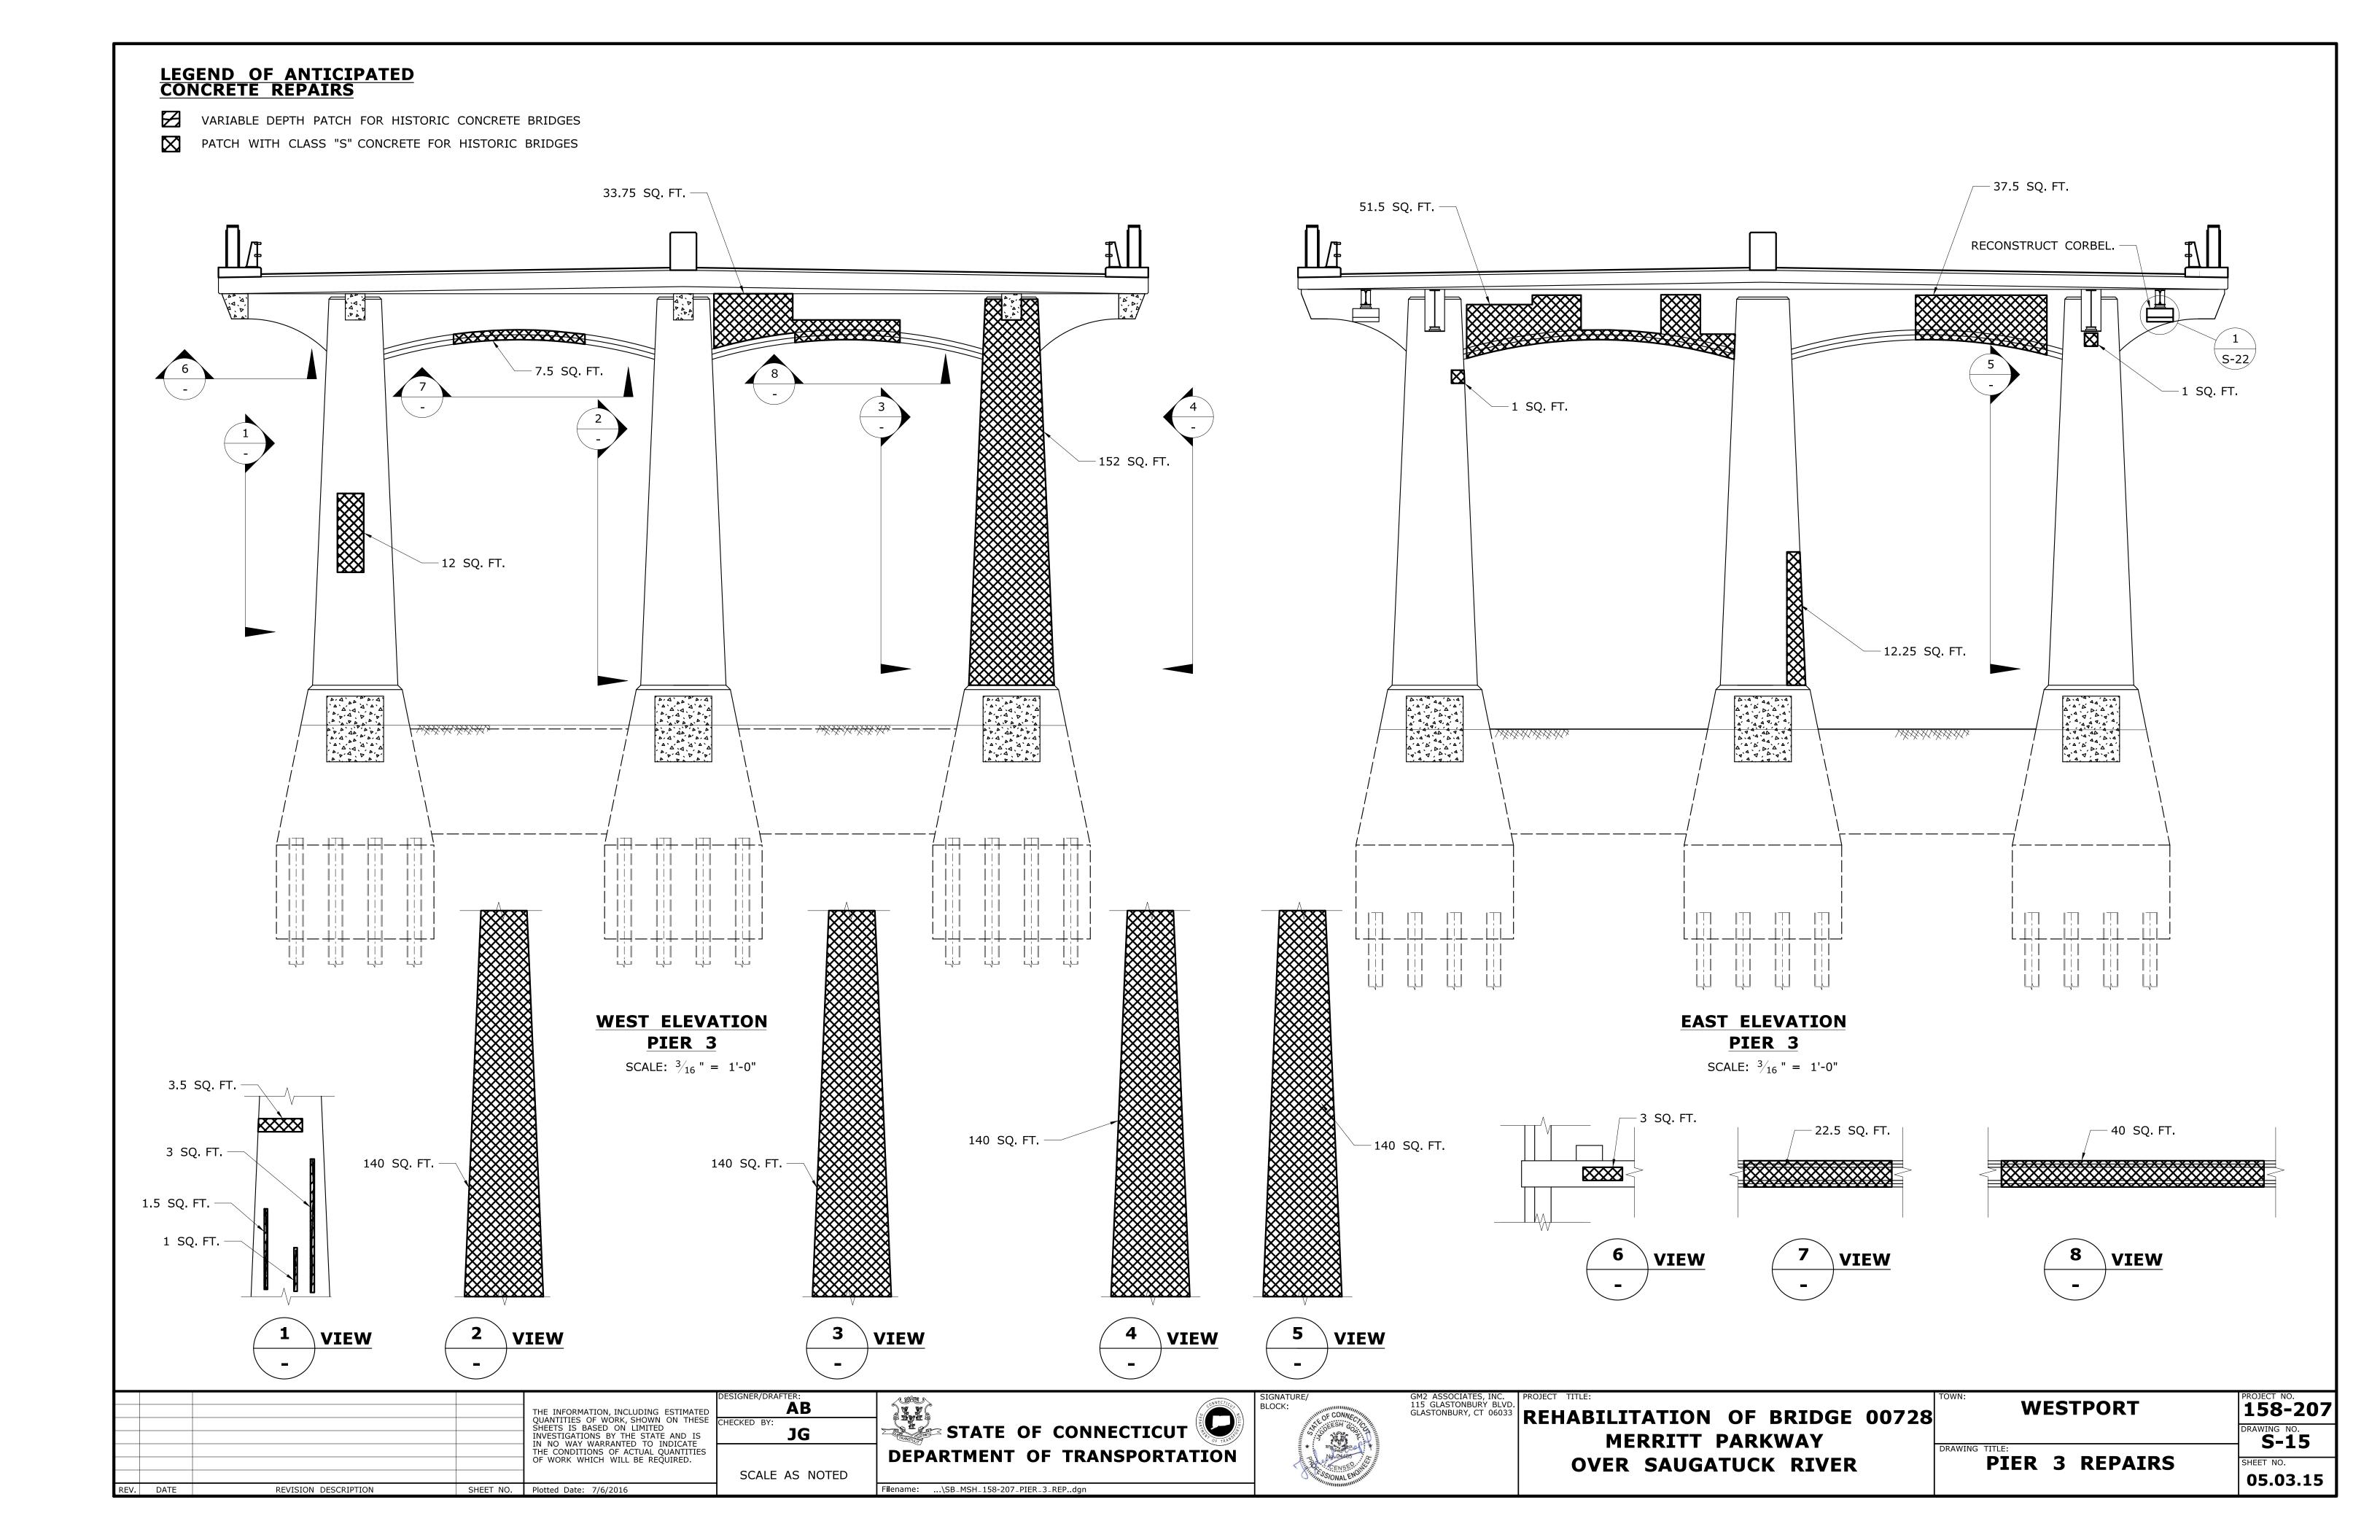PATCH WITH CLASS "S" CONCRETE FOR HISTORIC BRIDGES

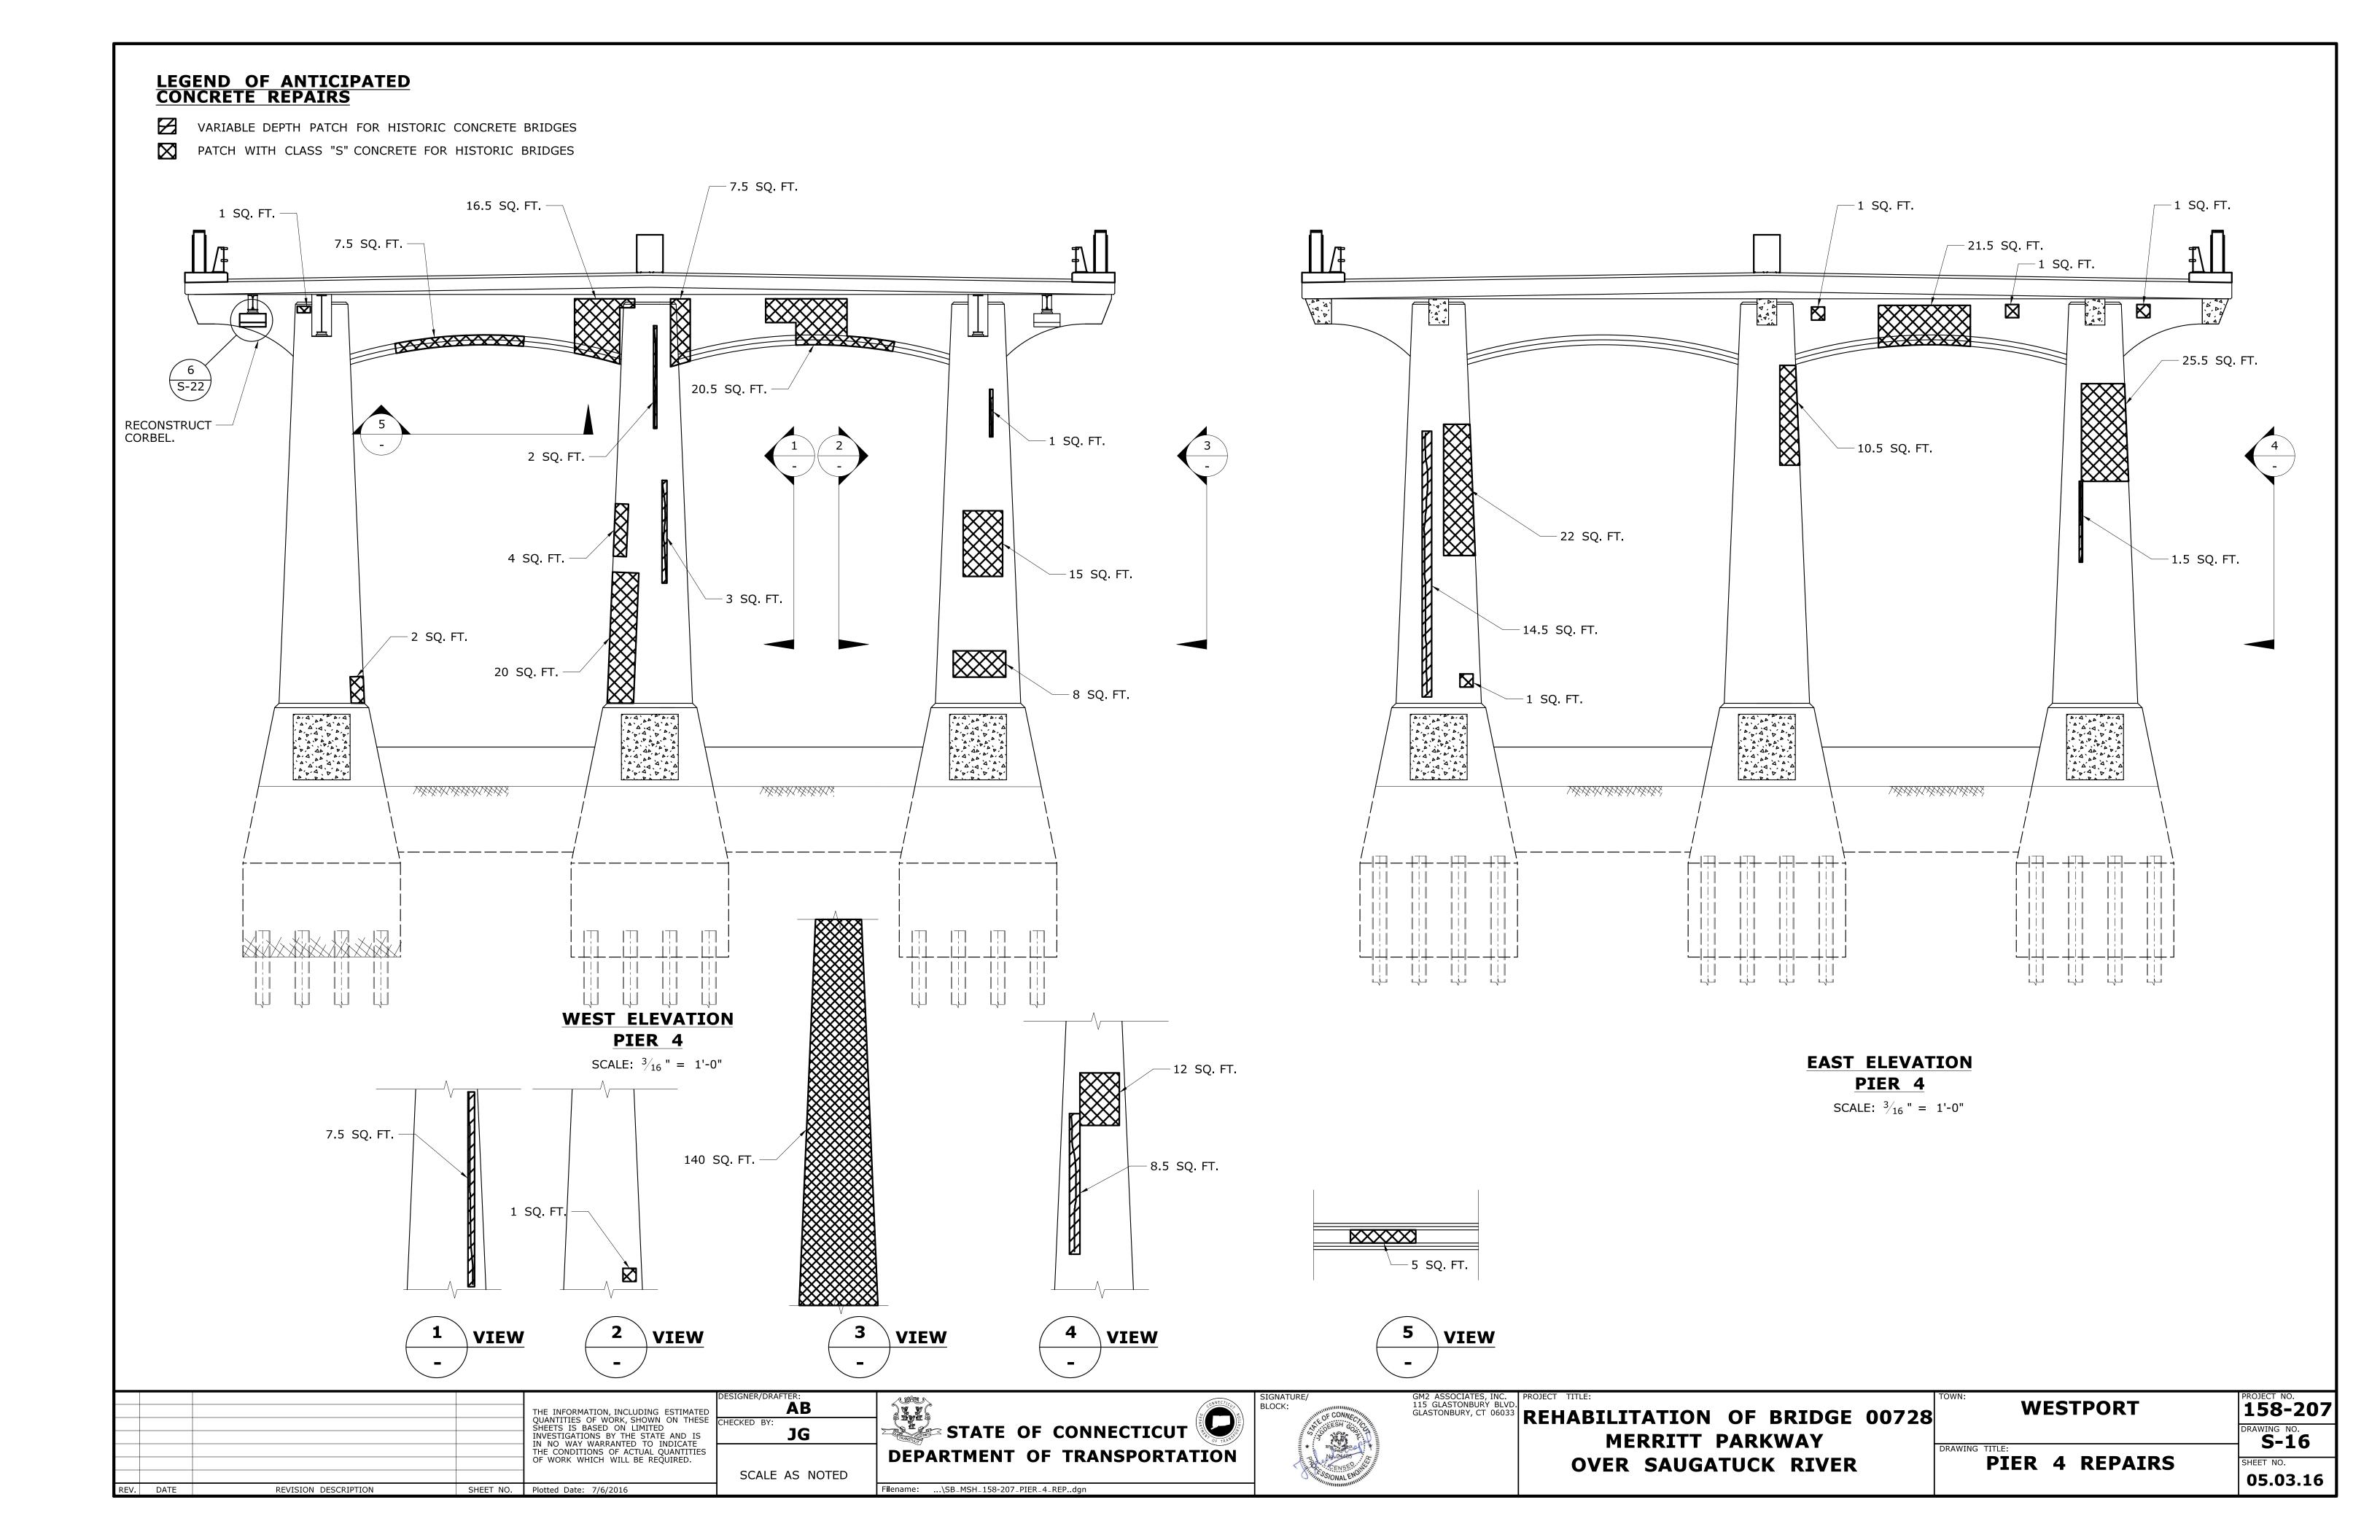


#### **WEST ELEVATION** PIER 5

SCALE:  $\frac{3}{16}$ " = 1'-0"

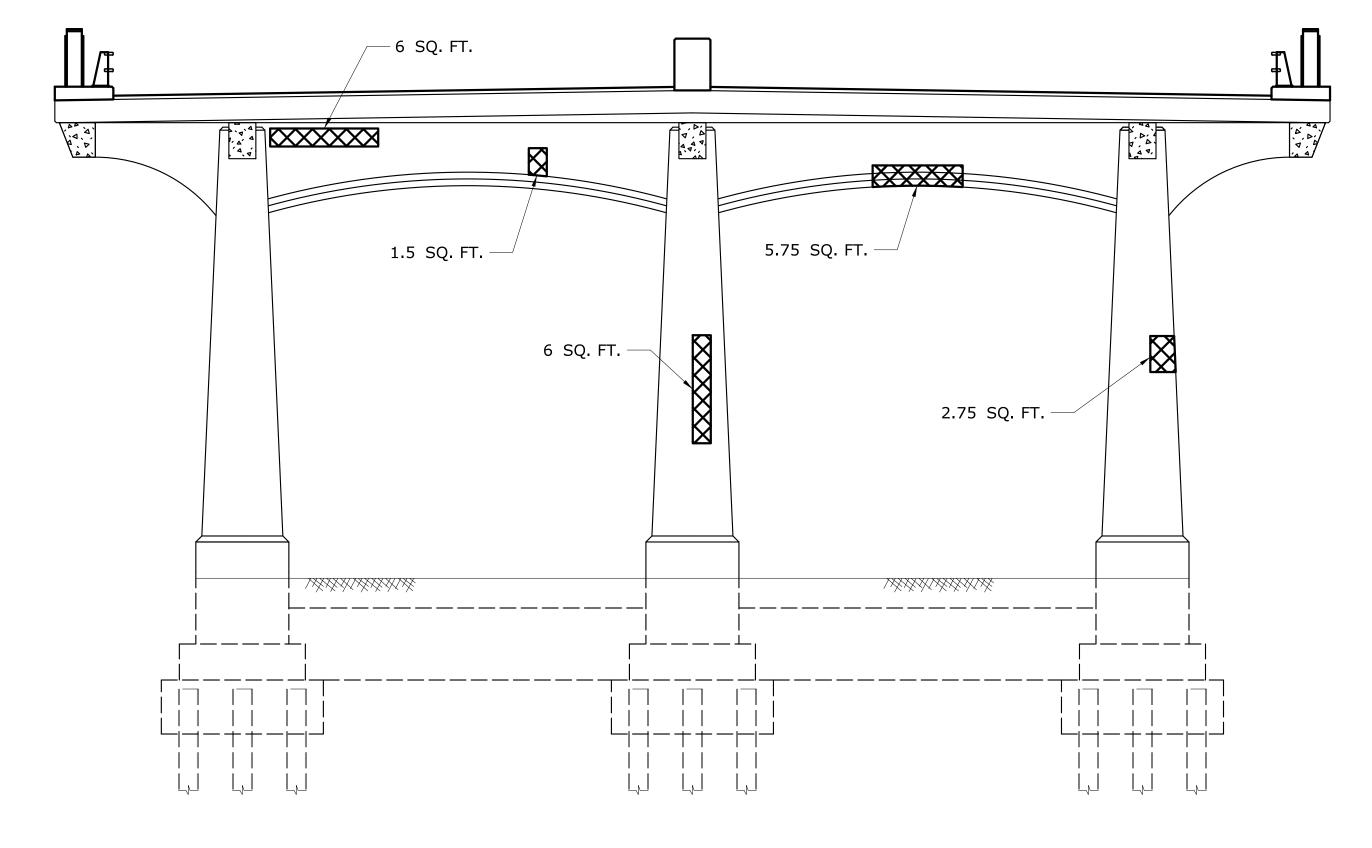


#### **EAST ELEVATION** PIER 5


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REV.	DATE	REVISION DESCRIPTION	SHEET NO.	Plotted Date: 7/6/2016	ĺ

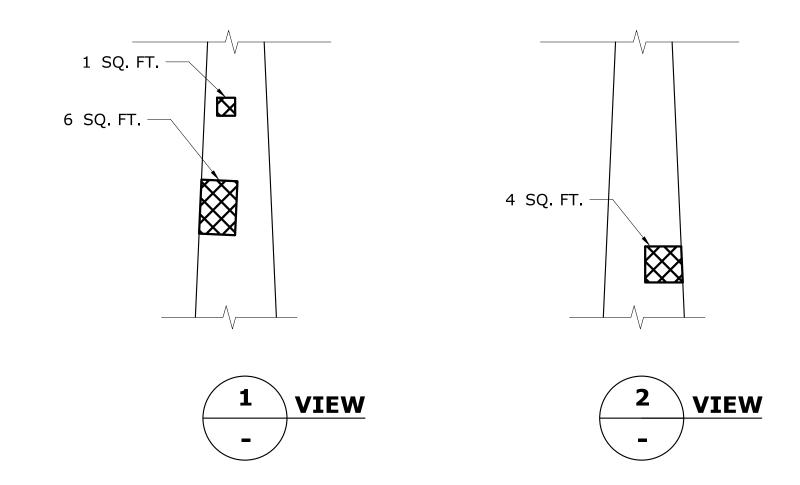

STATE OF CONNECTICUT DEPARTMENT OF TRANSPORTATION Filename: ...\SB\_MSH\_158-207\_PIER\_5\_REP..dgn

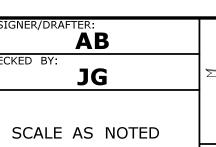

PROJECT TITLE:	TES, INC. BURY BLVD.
REHABILI	, CT 06033
ME	

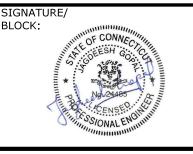TATION OF BRIDGE 00728 ERRITT PARKWAY **OVER SAUGATUCK RIVER** 


WESTPORT	PROJECT NO. <b>158-207</b>
	DRAWING NO.  S-17
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DTED 5 DEDATES	SHEET NO

05.03.17

PIER 5 REPAIRS

# LEGEND OF ANTICIPATED CONCRETE REPAIRS

- VARIABLE DEPTH PATCH FOR HISTORIC CONCRETE BRIDGES
- PATCH WITH CLASS "S" CONCRETE FOR HISTORIC BRIDGES

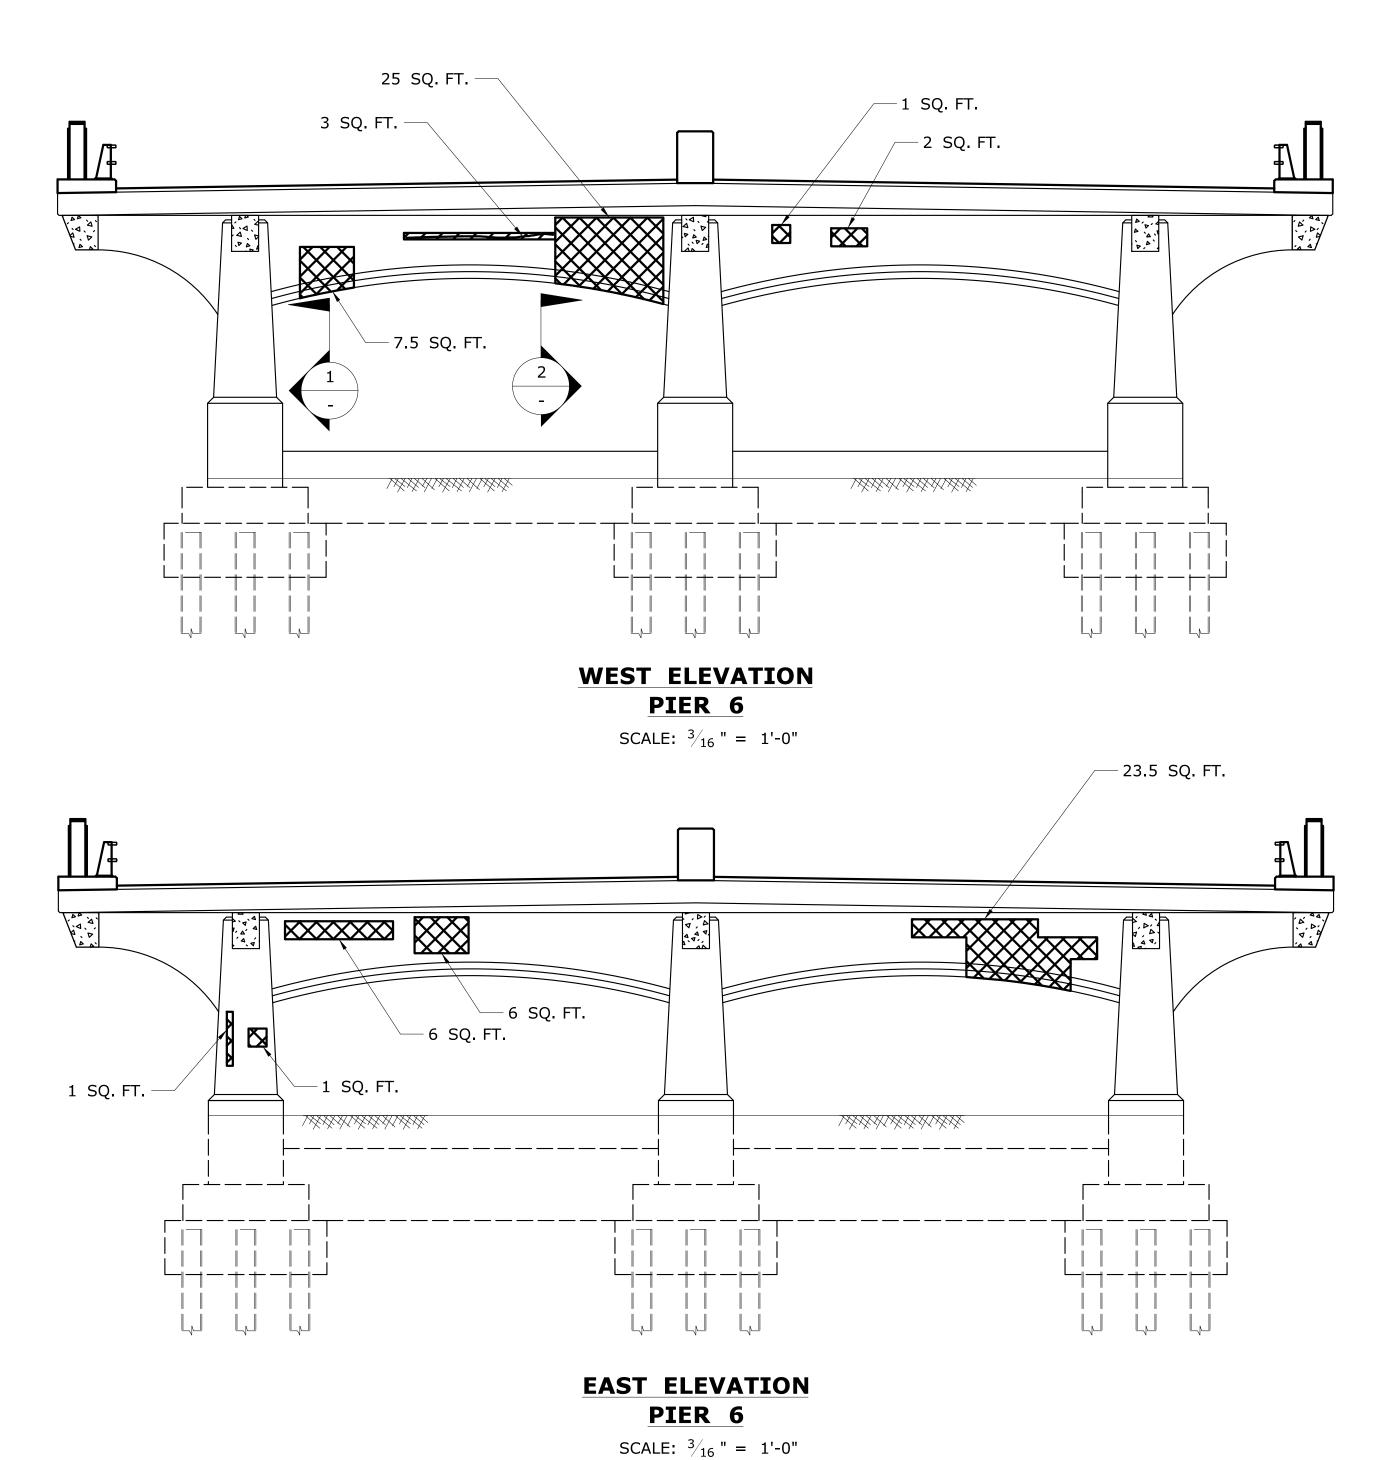



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				INVESTIGATIONS BY THE STATE AND IS IN NO WAY WARRANTED TO INDICATE	
				THE CONDITIONS OF ACTUAL QUANTITIES	
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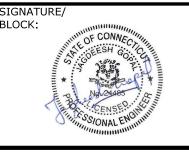
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SCALE AS NOTED



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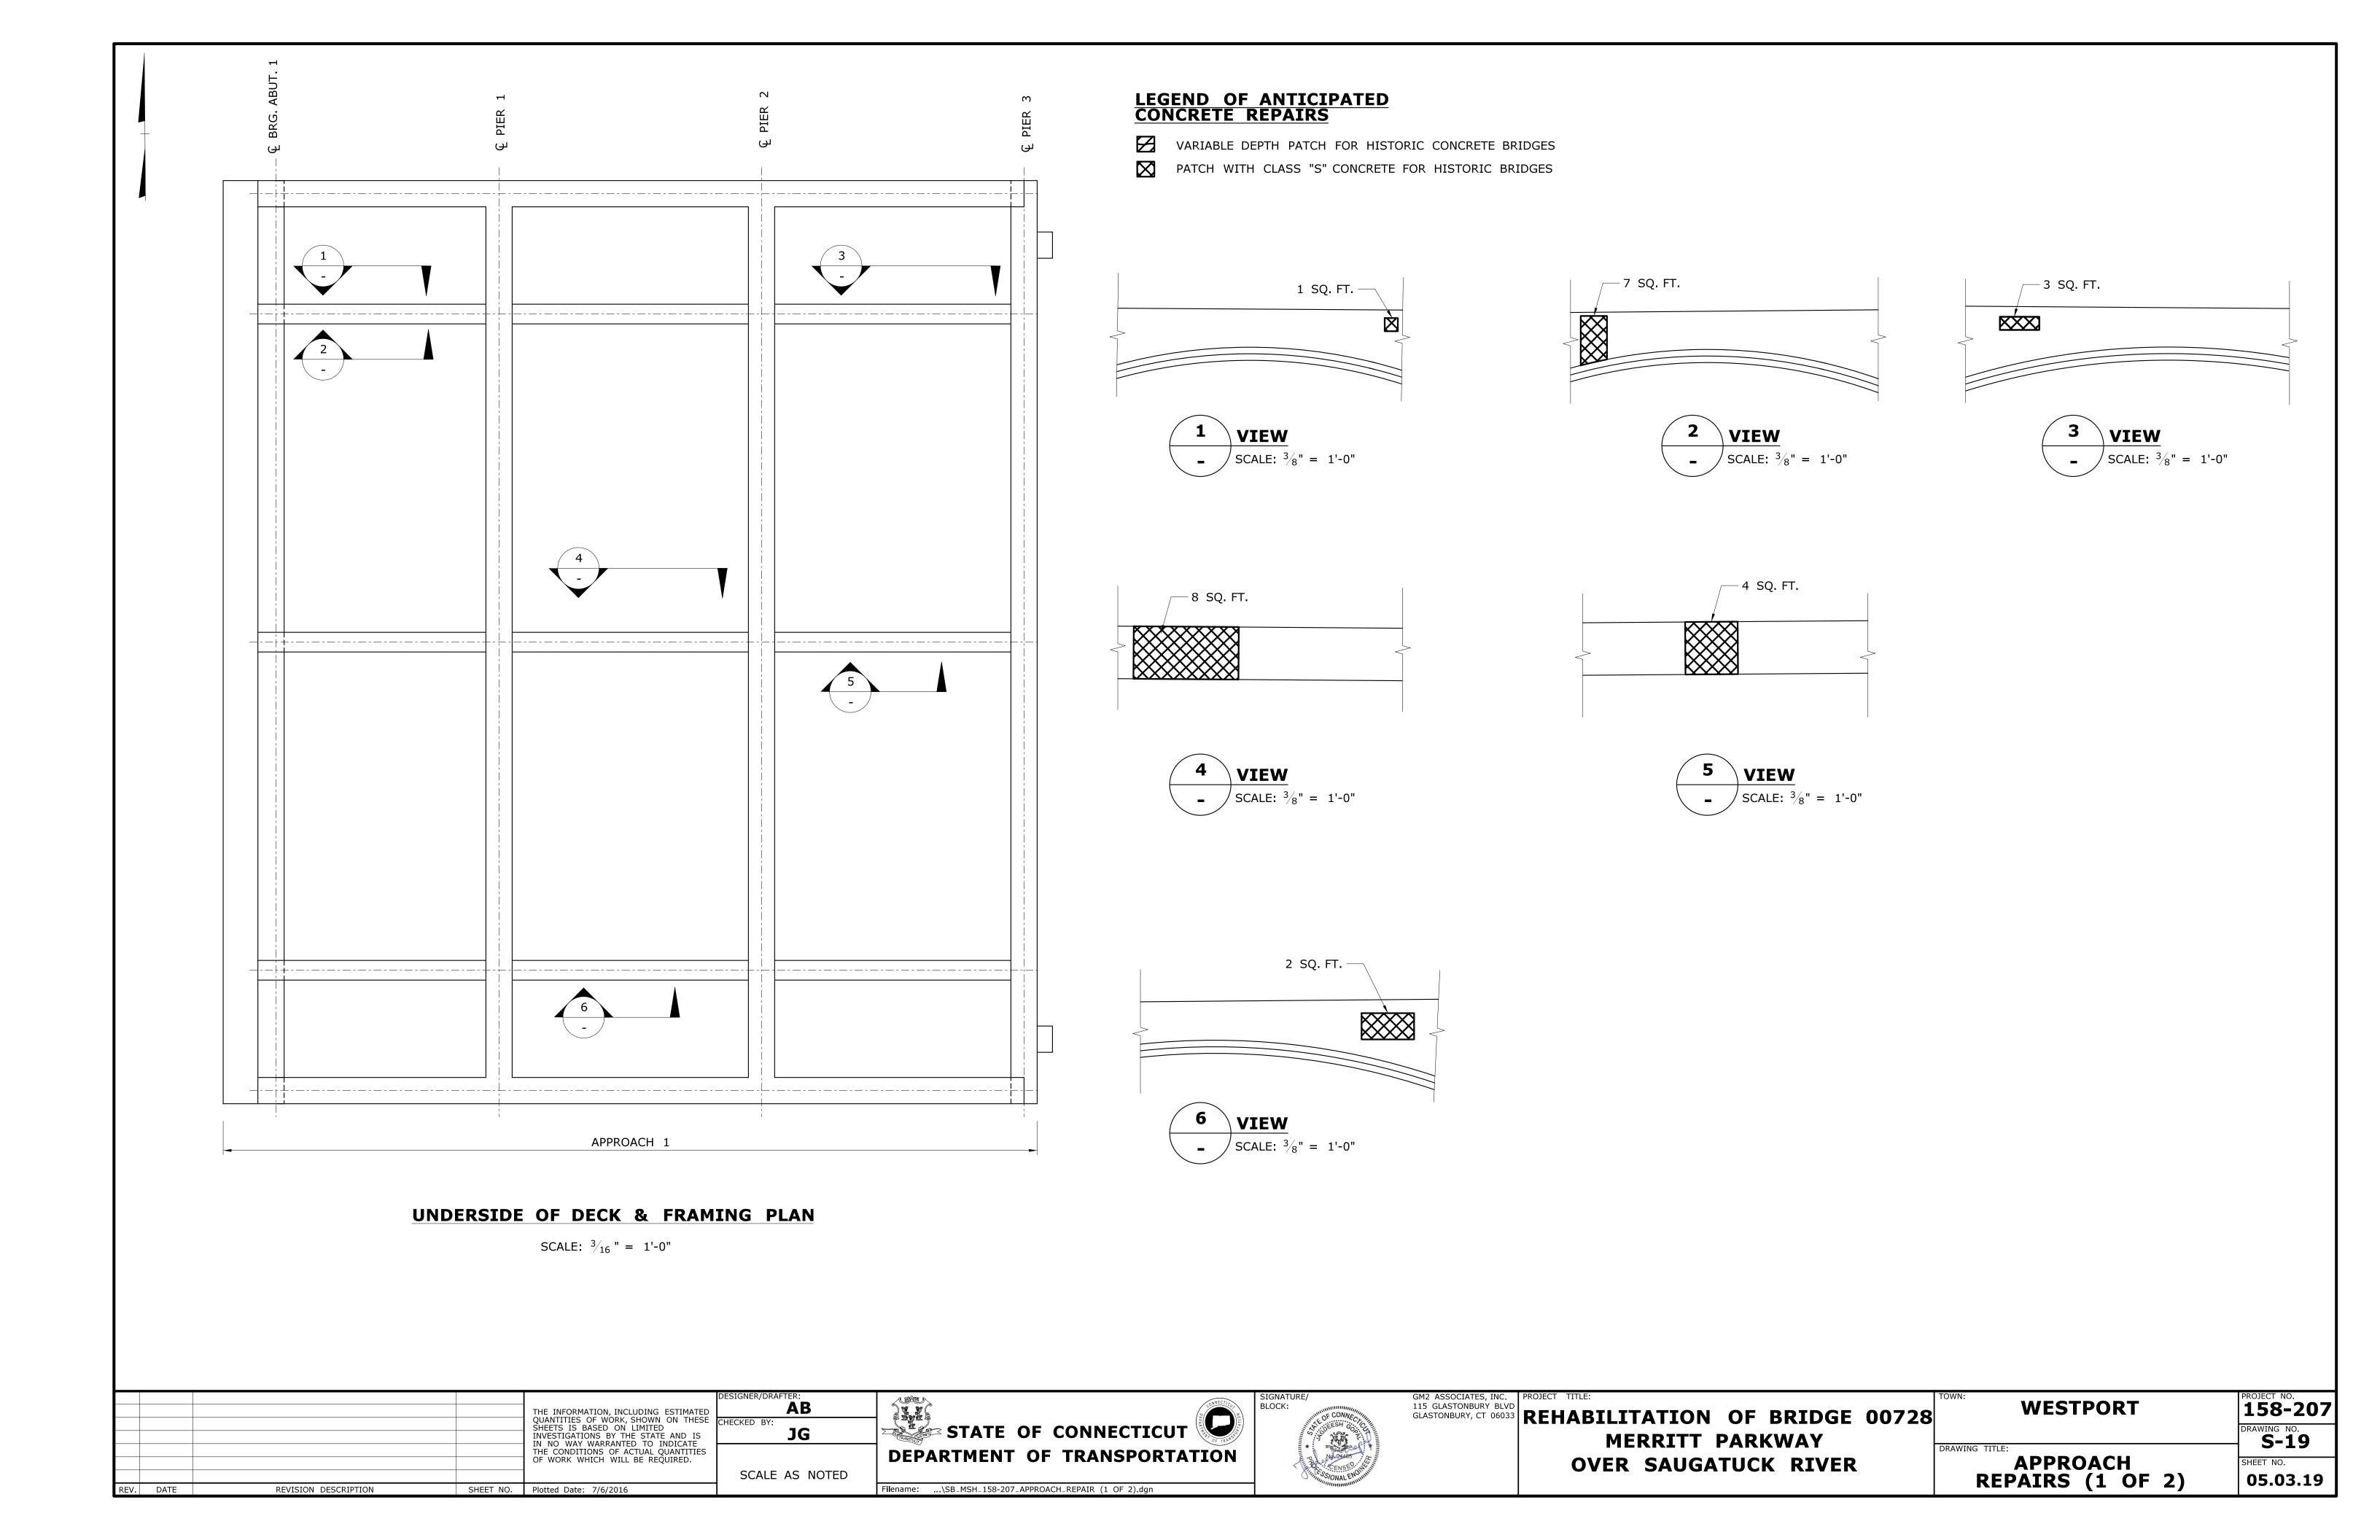
GM2 ASSOCIATES, INC.
115 GLASTONBURY BLVD.
GLASTONBURY, CT 06033


REHABILITATION OF BRIDGE 00728


MERRITT PARKWAY

OVER SAUGATUCK RIVER

WESTPORT	158-207
RAWING TITLE:	DRAWING NO. <b>S-18</b>
PIER 6 REPAIRS	SHEET NO. <b>05.03.18</b>



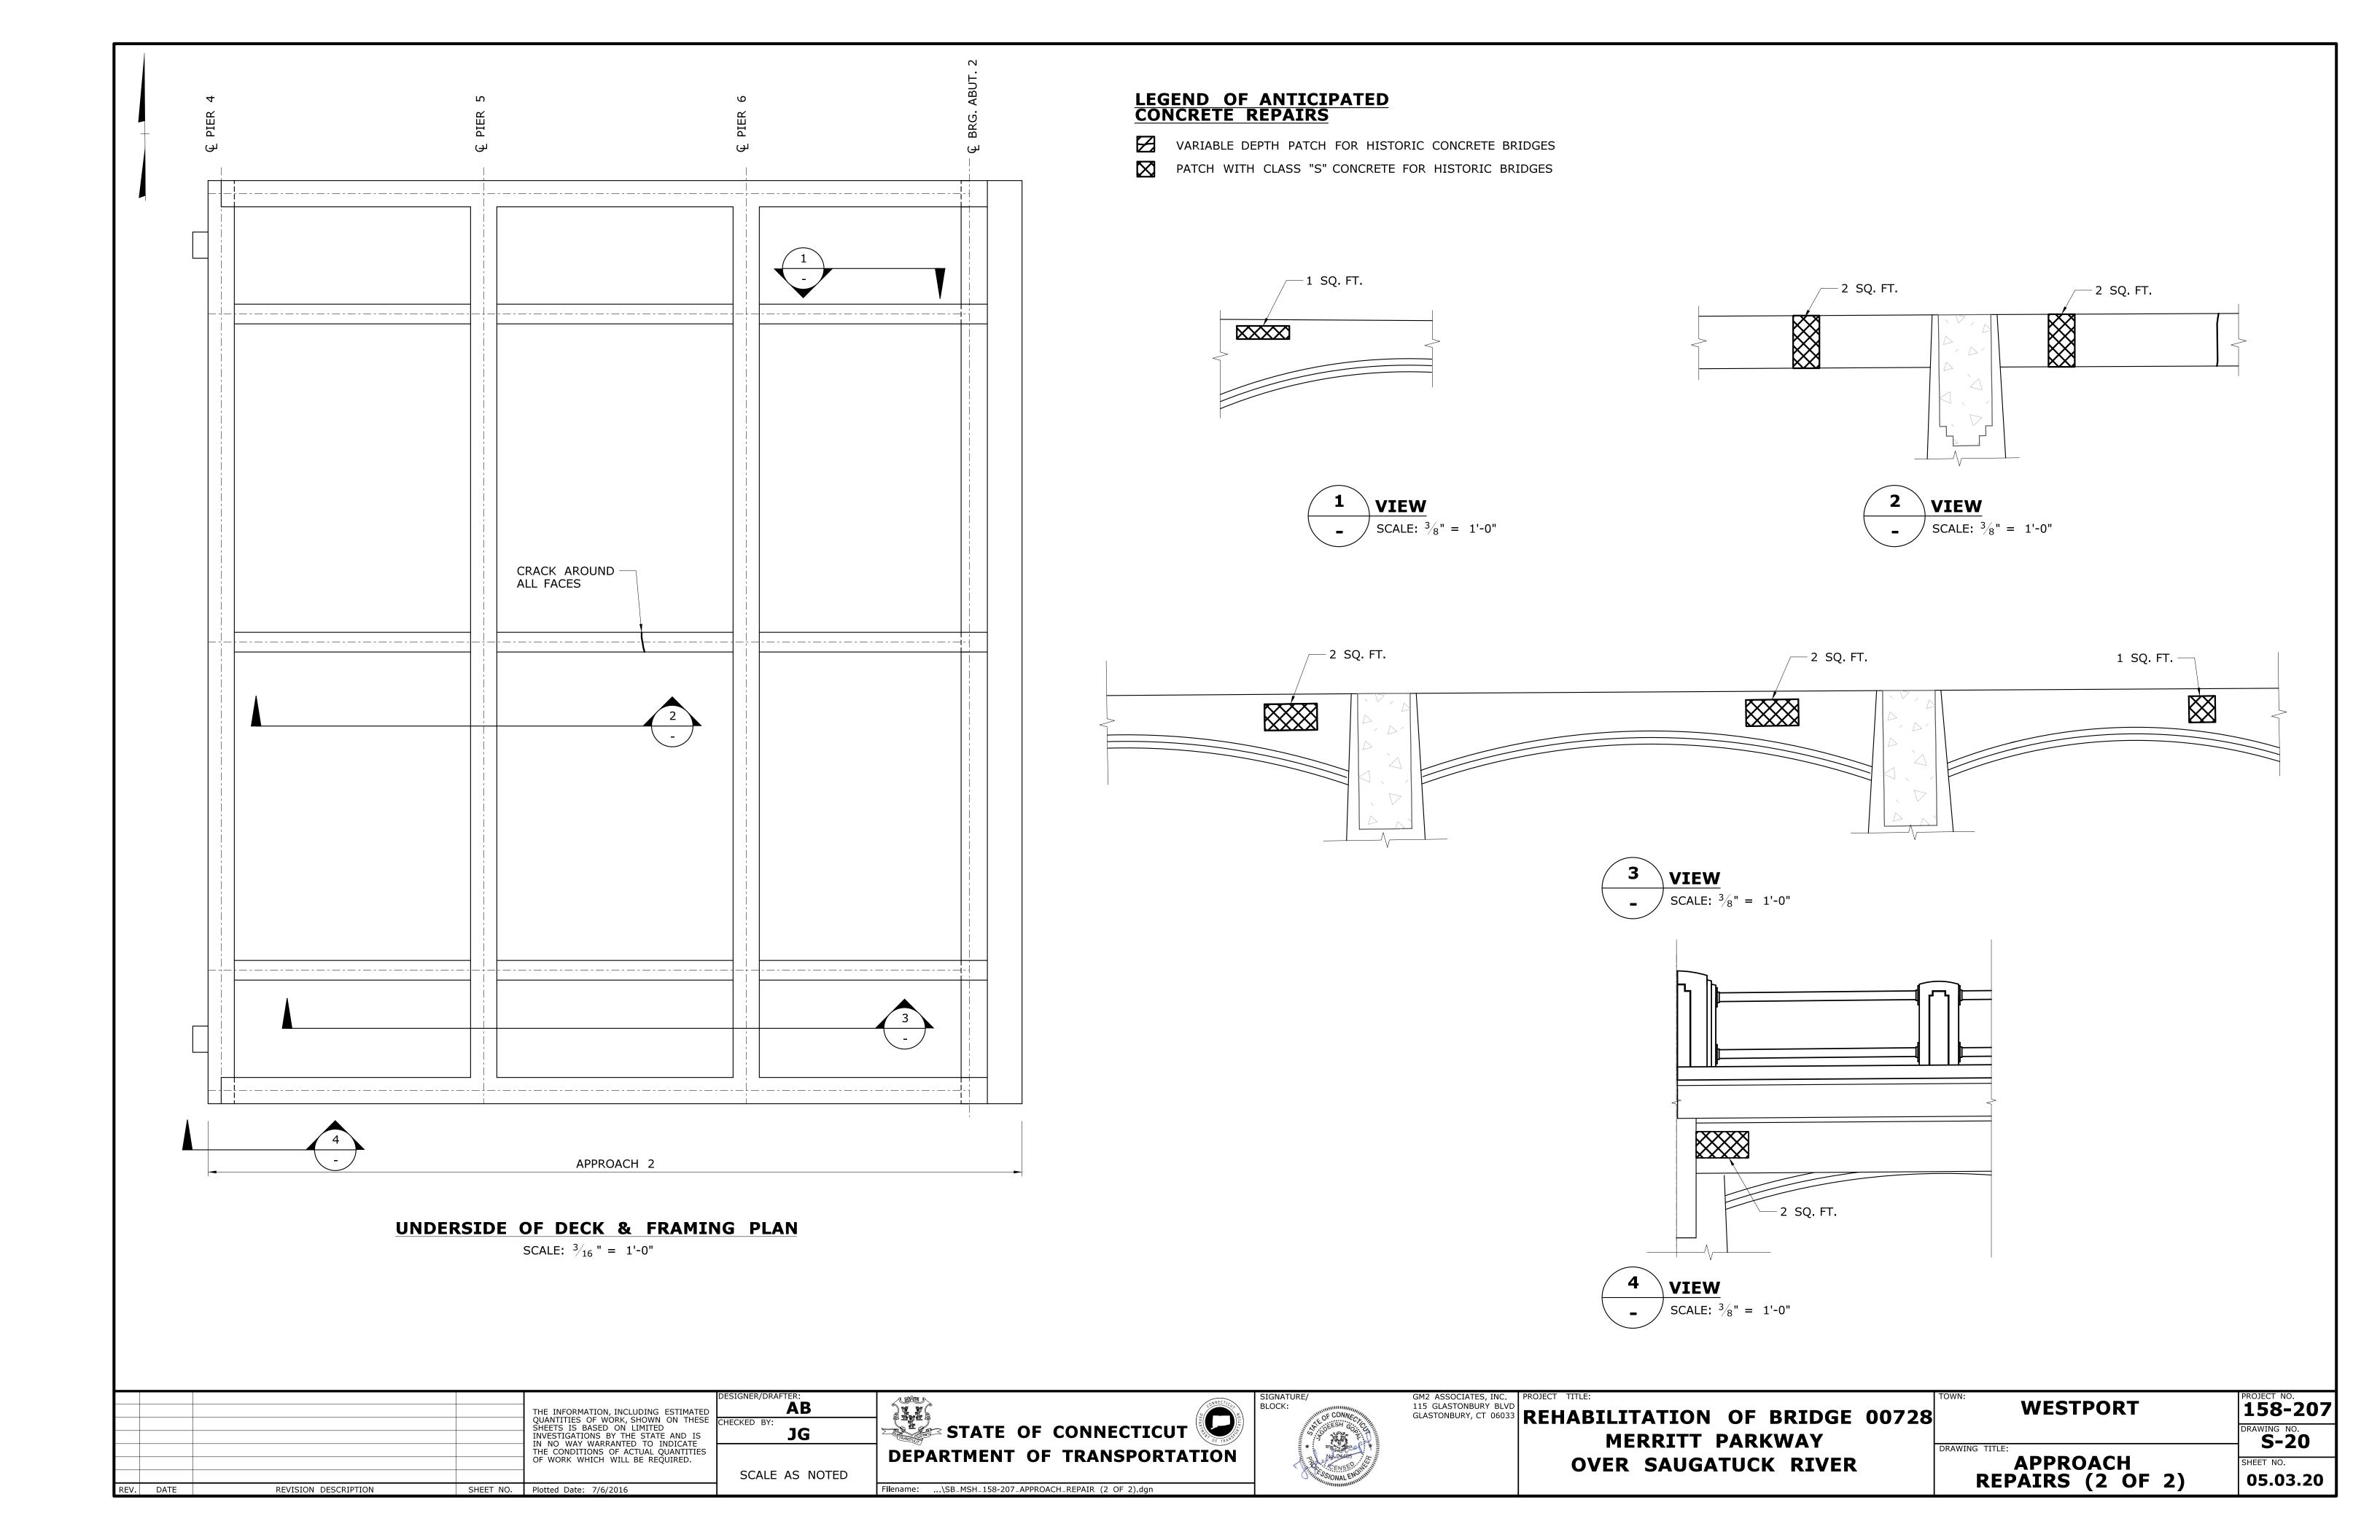

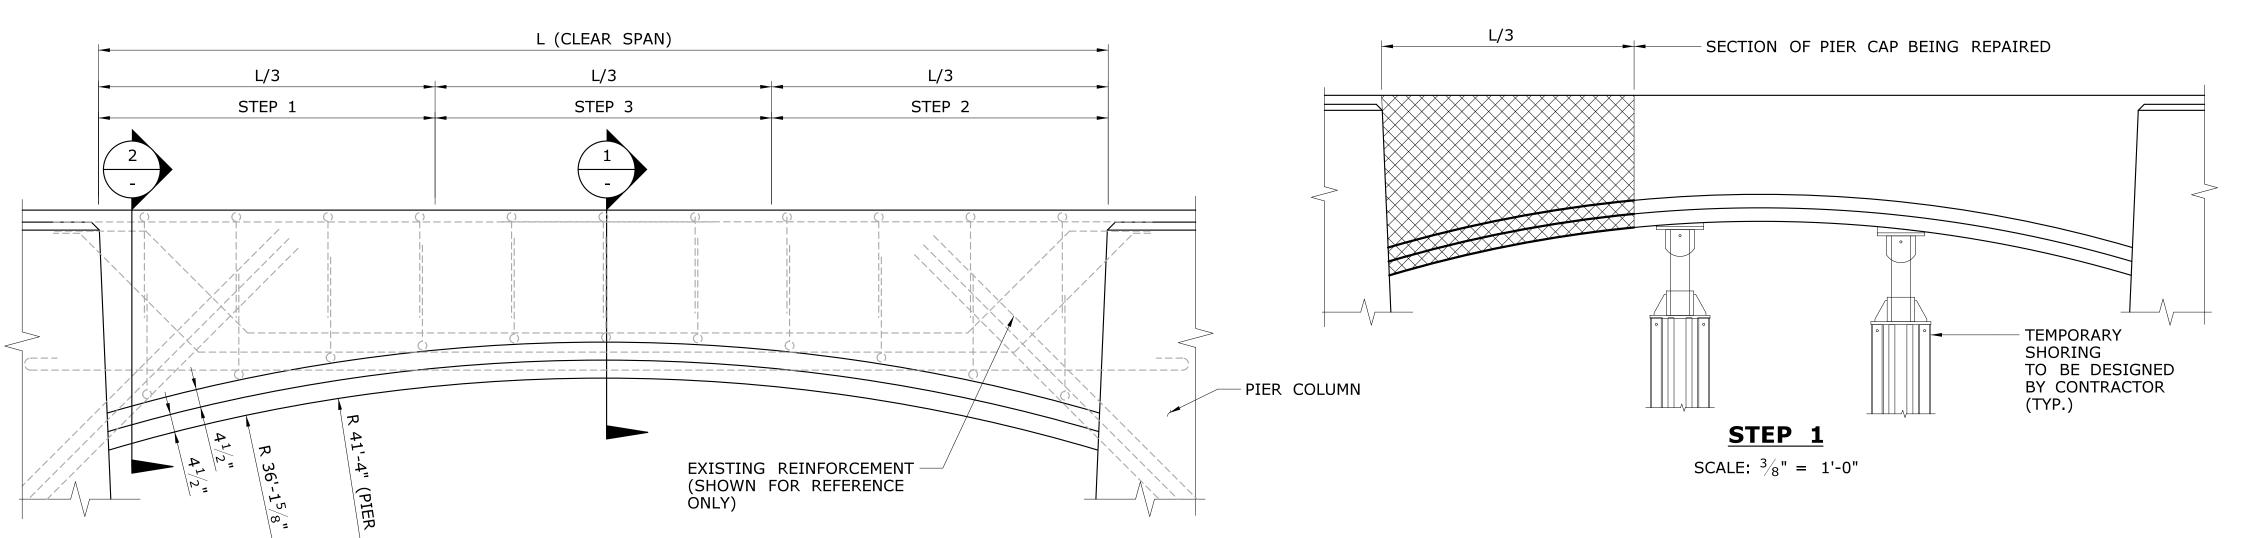

PIER SHORING	LOAD (SERVICE)
DC	57.0 KIPS
DW	5.4 KIPS
LL	96.1 KIPS

#### PIER SHORING NOTES:

- 1. THE INTENT OF SHORING THE PIER CAP ARE TO PROVIDE SUPPORT FOR THE CONCRETE DURING REHABILITATION.
- 2. SHORING HEADS SHOWN ARE FOR RISING THE SHORING SYSTEM ONLY BASED ON THE ASSUMED CONCEPT SHOWN ON THIS SHEET. NO JACKING IS REQUIRED.
- 3. SHORING TOWERS SHALL BE POSITIVELY ENGAGED WITH CONCRETE PIER CAP BEFORE COMMENCING ANY REPAIR OPERATIONS.


# LEGEND OF ANTICIPATED CONCRETE REPAIRS

REMOVE DETERIORATED CONCRETE TO SOUND CONCRETE


PIER CAP

SCALE:  $\frac{1}{2}$ " = 1'-0"

REMOVE SOUND CONCRETE AS REQUIRED TO 1" BEHIND REINFORCEMENT

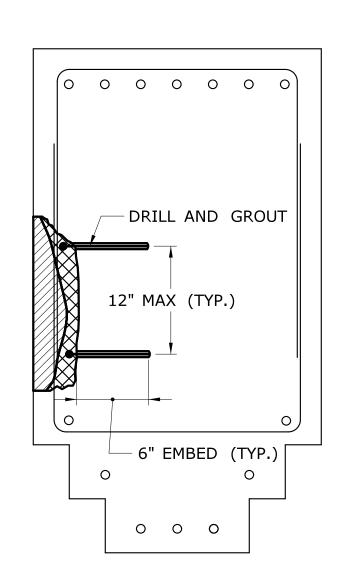


SECTION 1 IS SHOWN SECTION 2 IS SIMILAR

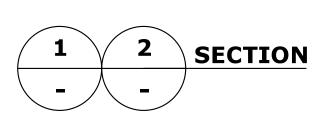


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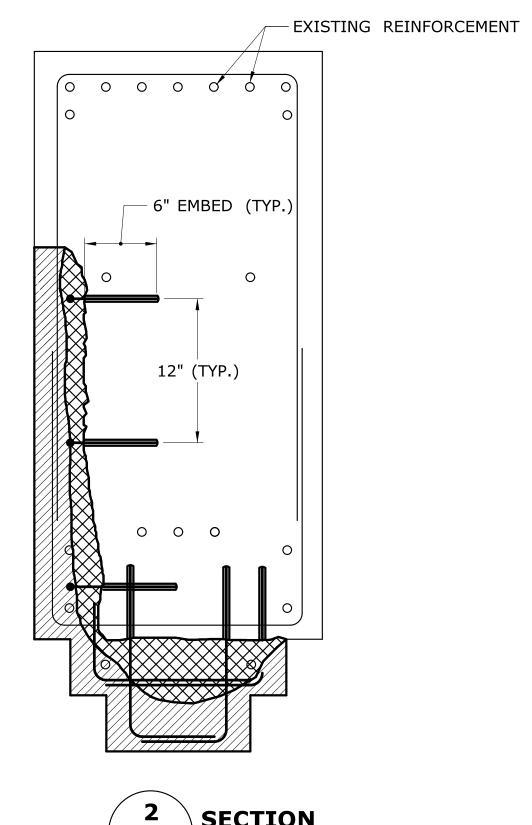
REV. DATE

TYPE 1 REPAIR SCALE:  $1\frac{1}{2}$ " = 1'-0"




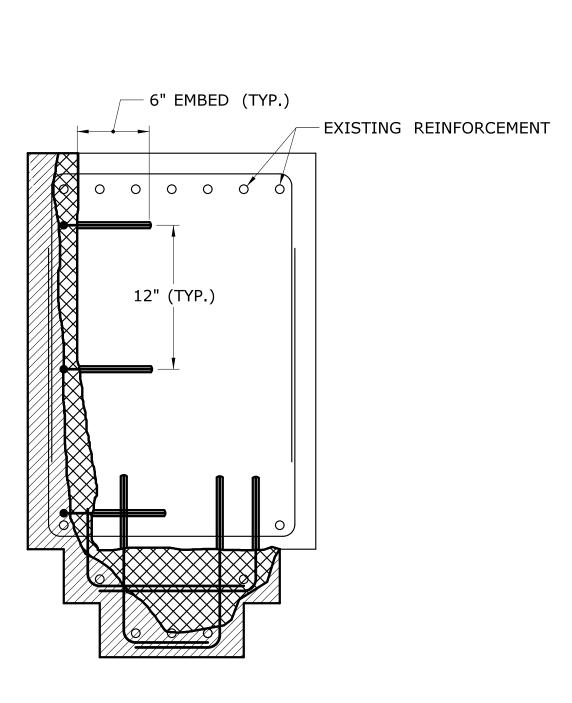




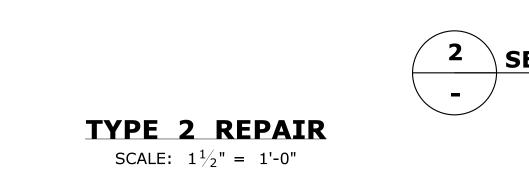



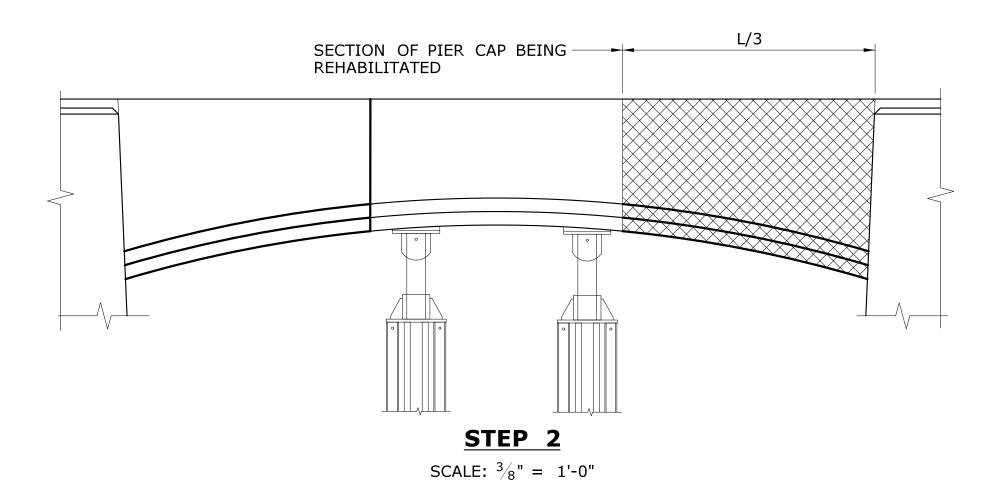

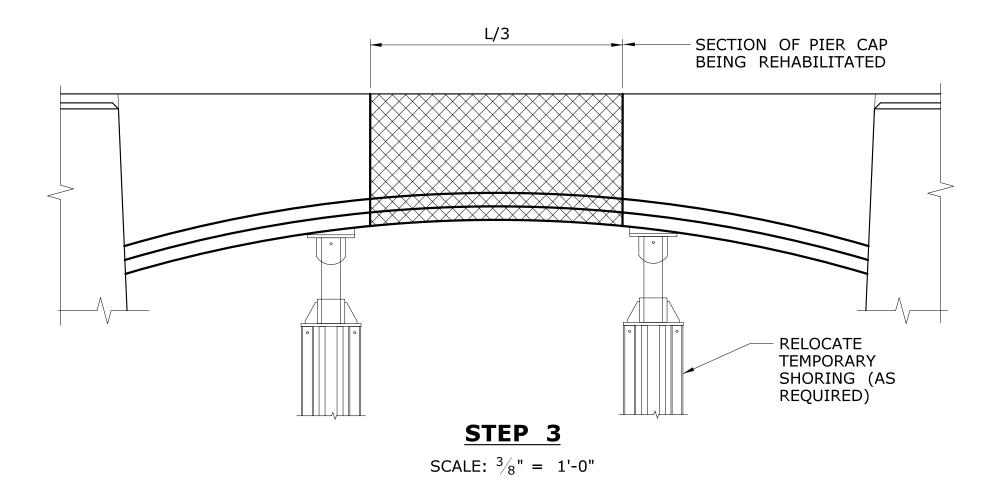


	THE INFORMATION, INCLUDING ESTIMATE QUANTITIES OF WORK, SHOWN ON THES SHEETS IS BASED ON LIMITED
	INVESTIGATIONS BY THE STATE AND IS IN NO WAY WARRANTED TO INDICATE THE CONDITIONS OF ACTUAL QUANTITIES OF WORK WHICH WILL BE REQUIRED.

SHEET NO. Plotted Date: 7/6/2016

SCALE AS NOTED

STATE OF CONNECTICUT **DEPARTMENT OF TRANSPORTATION** 


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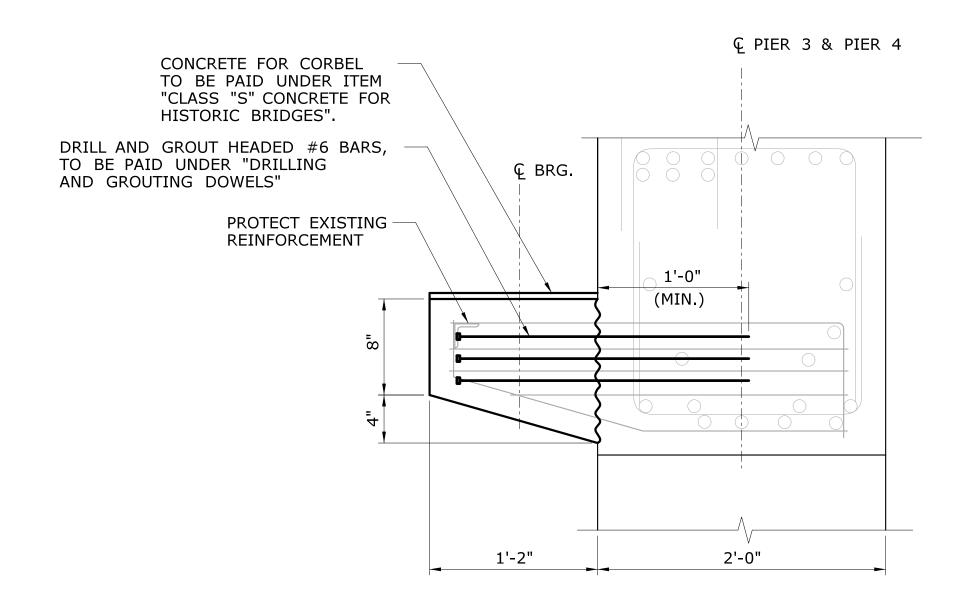


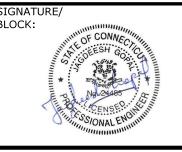GM2 ASSOCIATES, INC.
115 GLASTONBURY BLVD.
GLASTONBURY, CT 06033

REHABILITATION OF BRIDGE 00728 **MERRITT PARKWAY OVER SAUGATUCK RIVER** 

TOWN:	WESTPORT	PROJECT NO. <b>158-207</b>
		DRAWING NO. <b>S-21</b>
DRAWING TITLE:	PIER CAP REPAIR	SHEET NO. <b>05.03.21</b>



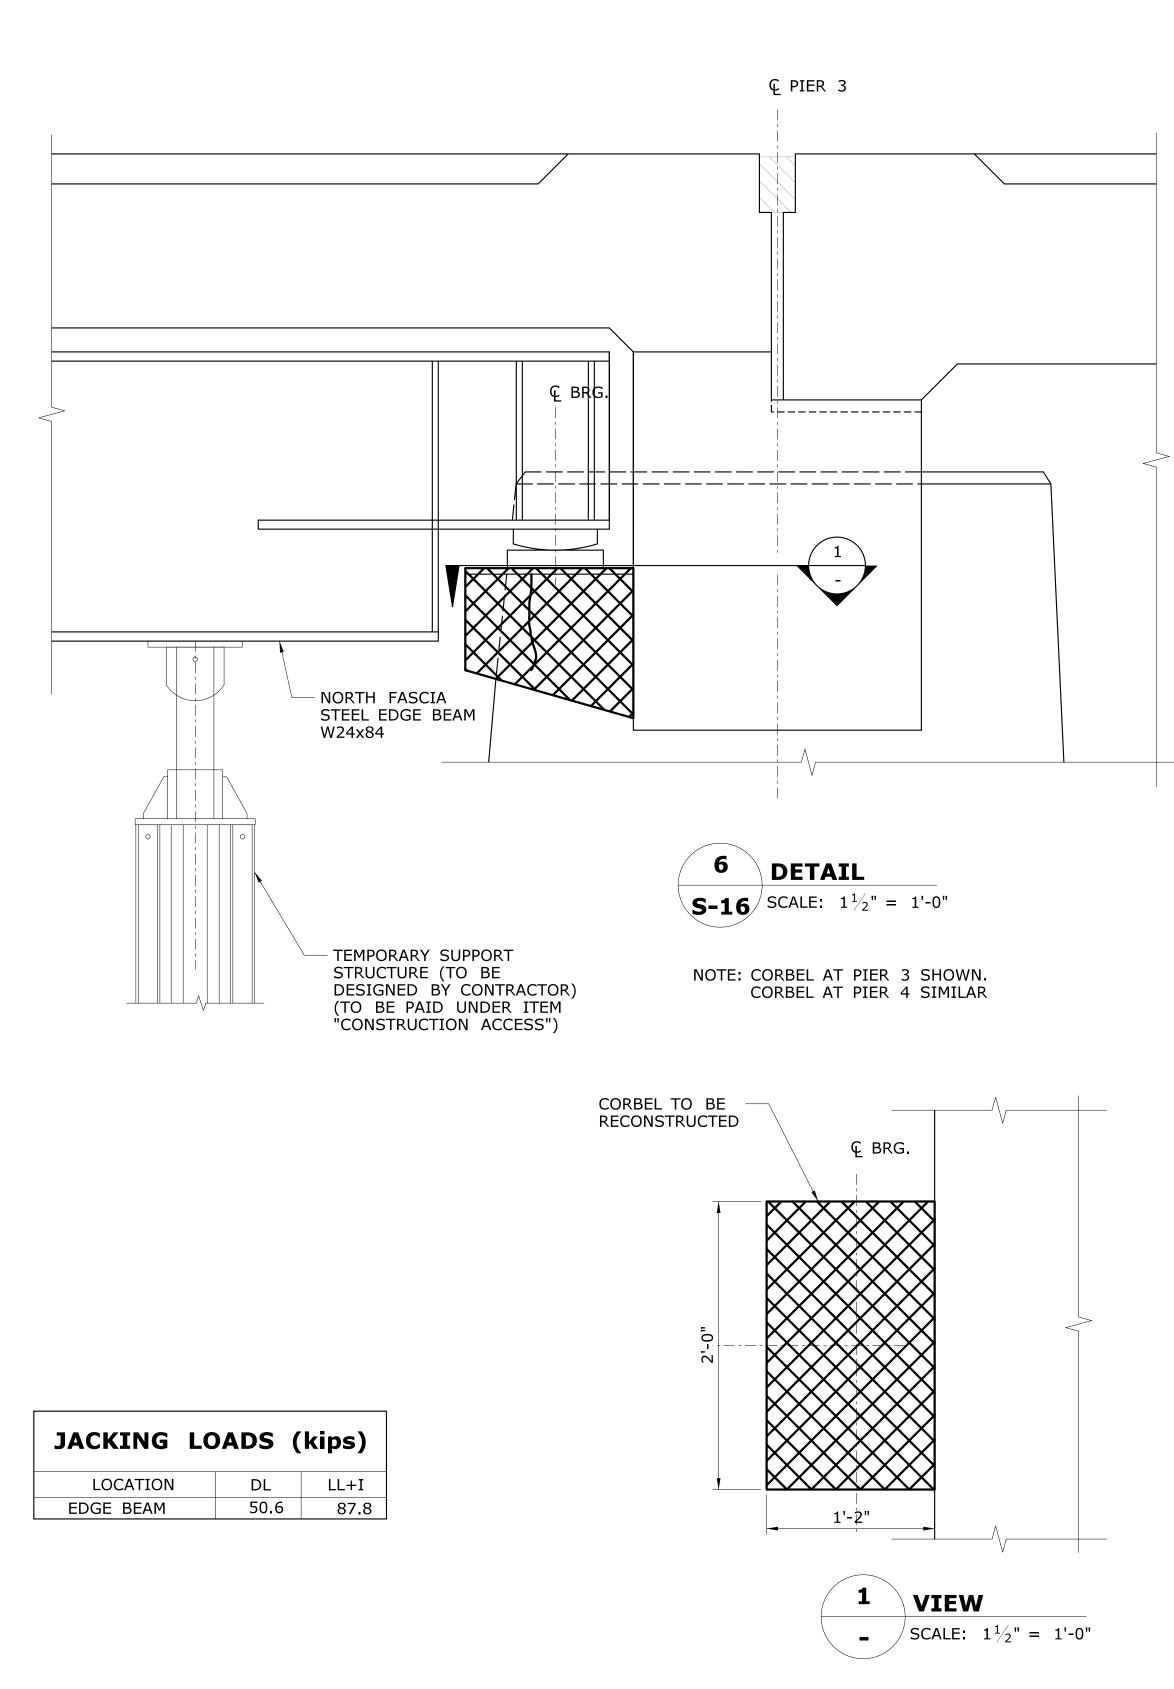


#### TYPICAL CORBEL REINFORCEMENT

SCALE:  $1\frac{1}{2}$ " = 1'-0"

#### **NOTES:**

- 1. CORBEL RECONSTRUCTION ON NORTHSIDE OF PIER 3 & 4 SHOULD BE PERFORMED DURING STAGE 3 AFTER STEEL REPAIRS ARE COMPLETED.
- 2. REPAIR OF DAMAGED REINFORCING STEEL SHALL BE PERFORMED AS DIRECTED BY THE ENGINEER AND SHALL BE PAID FOR AT THE CONTRACT BID PRICE FOR "CLASS "S" CONCRETE FOR HISTORIC BRIDGES".

			THE INFORMATION, INCLUDING ESTIMATED QUANTITIES OF WORK, SHOWN ON THESE SHEETS IS BASED ON LIMITED INVESTIGATIONS BY THE STATE AND IS IN NO WAY WARRANTED TO INDICATE THE CONDITIONS OF ACTUAL QUANTITIES OF WORK WHICH WILL BE REQUIRED.	DESIGNER/DRAFTER:  AB  CHECKED BY:  JG	STATE OF CONNECTICUT  DEPARTMENT OF TRANSPORTATION	SIGNATURE/ BLOCK:  WHO THE STATE OF THE STAT	GM2 ASSOCIATES, INC. 115 GLASTONBURY BLVD. GLASTONBURY, CT 06033  REHABILITATION OF BRIDGE 00728  MERRITT PARKWAY  OVER SAUGATUCK RIVER	B WESTPORT  DRAWING TITLE:  CORBEL REPAIR	PROJECT NO.  158-207  DRAWING NO.  S-22  SHEET NO.
REV. DATE RI	EVISION DESCRIPTION	SHEET NO.	Plotted Date: 7/6/2016	SCALE AS NOTED	Filename:\SB_MSH_158-207_CORBEL_REPdgn	OFFICE SONAL ENGLISH			05.03.22

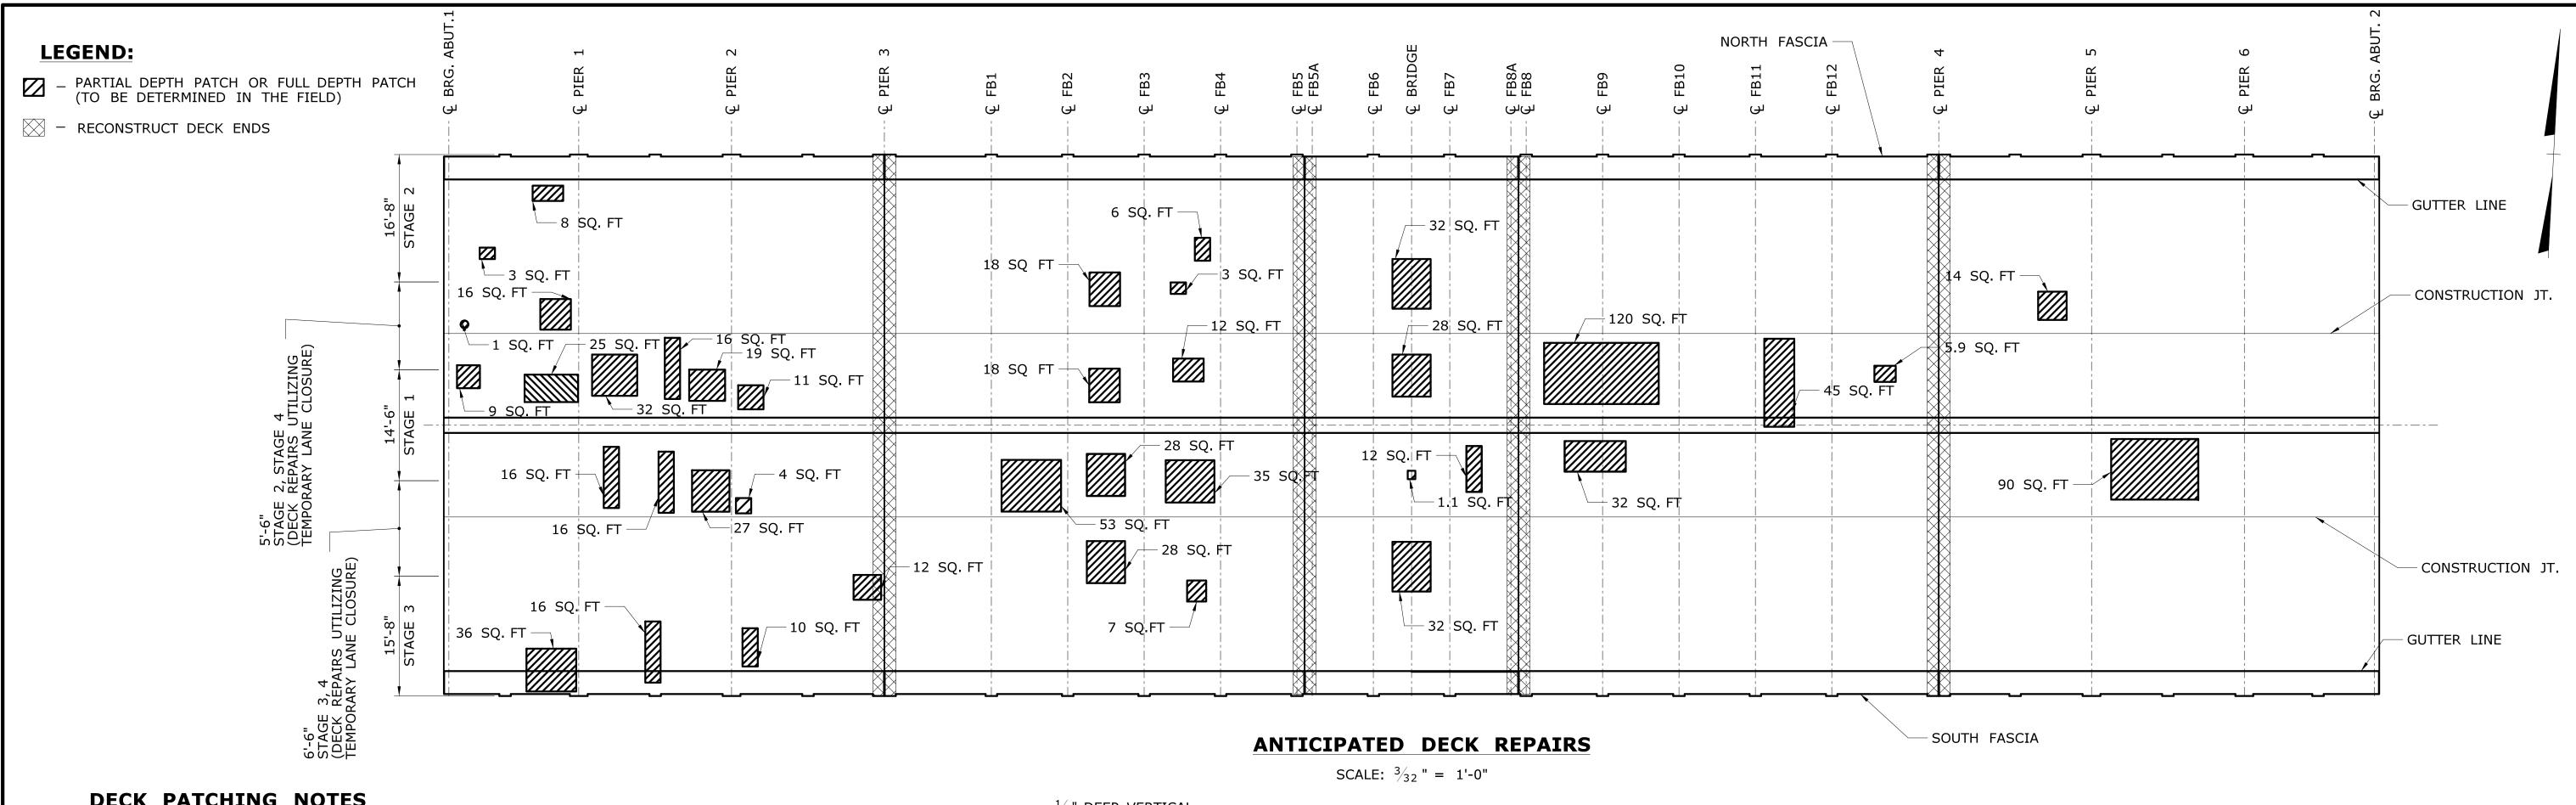

#### **DECK PATCHING NOTES**

- 1. AFTER REMOVAL OF DETERIORATED DECK CONCRETE, THE REINFORCEMENT MAY BE FOUND TO BE DETERIORATED PAST THE POINT THAT IT IS ACCEPTABLE TO REUSE THE EXISTING REINFORCING SHALL BE REPLACED WHEN:
  - EXISTING REINFORCING HAS 25% OR MORE OF SECTION LOSS
  - EXISTING REINFORCING IS BROKEN - AS ORDERED BY THE ENGINEER
- 2. ALL EXPOSED REINFORCING STEEL TO REMAIN SHALL BE THOROUGHLY CLEANED AND REUSED IN ACCORDANCE WITH THE SPECIAL PROVISIONS "PARTIAL DEPTH PATCH" AND "FULL DEPTH PATCH (HIGH EARLY STRENGTH CONCRETE".
- 3. REMOVE CONCRETE AS FAR AS REQUIRED TO EXPOSE SOUND REINFORCEMENT TO LAP THE NEW BARS. THE CONCRETE SHALL BE REMOVED TO A MINIMUM DEPTH OF 1" BELOW THE NEW BARS. REMOVAL IS TO STOP ONCE CONCRETE BEING REMOVED HAS FRACTURE LINES THAT PASS THROUGH AGGREGATE.
- 4. A CHISEL BIT SHALL BE USED FOR THE PNEUMATIC HAMMER, A POINTED BIT SHALL NOT BE USED.
- 5. MATCH EXISTING BAR SIZES AND SPACING FOR BOTH LONGITUDINAL AND TRANSVERSE BARS.
- 6. REINFORCEMENT SHALL BE UNCOATED AND CONFORM TO ASTM A615, GRADE 60.
- 7. IN DETERIORATED AREAS OF CONCRETE, WHERE AREAS OF POP-OUTS ARE CAUSED BY REMOVAL OF DETERIORATED CONCRETE, THE FULL DEPTH OF SLAB SHALL BE REPAIRED AND SHALL BE PAID FOR UNDER ITEM' "FULL DEPTH PATCH (HIGH EARLY STRENGTH CONCRETE)". WHERE POP-OUTS ARE CREATED IN GOOD CONCRETE DUE TO REMOVAL OPERATIONS, THEY SHALL BE REPAIRED AT THE CONTRACTOR'S EXPENSE.
- 8. AS DIRECTED BY THE ENGINEER, UPON REMOVAL OF THE FORM WORK, ALL VOIDS AND HONEYCOMB ON THE SURFACE SHALL BE FILLED WITH THE SAME MATERIAL AS USED FOR "FULL DEPTH PATCH (HIGH EARLY STRENGTH CONCRETE)" AND FINISHED TO CONFORM TO THE SURROUNDING CONCRETE SURFACE. ABSOLUTELY NO FORM WORK SHALL BE LEFT IN PLACE.
- 9. THE COST OF REMOVAL OF THE DETERIORATED CONCRETE INCLUDING THE  $\frac{1}{2}$ " SAW CUT, AND FURNISHING AND PLACING THE PATCHING MATERIAL SHALL BE INCLUDED FOR PAYMENT UNDER THE ITEMS "PARTIAL DEPTH PATCH" OR "FULL DEPTH PATCH (HIGH EARLY STRENGTH CONCRETE" AS APPLICABLE.
- 10. REPAIR OF DAMAGED REINFORCING STEEL SHALL BE INCLUDED FOR PAYMENT UNDER THE ITEMS "PARTIAL DEPTH PATCH" OR "FULL DEPTH PATCH (HIGH EARLY STRENGTH CONCRETE)".
- 11. APPROPRIATELY SIZED MECHANICAL SPLICES SHALL BE PERMITTED IN LIEU OF LAP SPLICES. THE COST OF SPLICES SHALL BE INCLUDED UNDER THE ITEMS "PARTIAL DEPTH PATCH" OR "FULL DEPTH PATCH (HIGH EARLY STRENGTH CONCRETE)".

#### $\frac{1}{2}$ " DEEP VERTICAL SAW CUT ALL AROUND REMOVE ALL DETERIORATED CONCRETE SEE "FULL" AND "PARTIAL (TYP.) FOR FULL DEPTH OF THE SLAB AND DEPTH PATCH" DETAILS REPLACE WITH PATCHING MATERIAL ABOVE FOR ADDITIONAL 2" COVER AT SPLICE EXISTING MAIN NOTES AND DIMENSIONS END OF BAR REINFORCEMENT (TYP.) REPLACEMENT STEEL REMOVE BROKEN — - SEE NOTE 2 FORMS SHALL BE SUPPORTED IN A SEE NOTE 4 **EXISTING** OR DAMAGED MANNER APPROVED BY THE ENGINEER. REINFORCEMENT - SEE NOTE 5 REINFORCING COST INCLUDED IN ITEM "FULL DEPTH (TYP.) STEEL PATCH (HIGH EARLY **FULL DEPTH PATCH** STRENGTH CONCRETE)". SCALE: 1'' = 1'-0''REPAIR OF DAMAGED REINFORCING STEEL SCALE: 1'' = 1'-0'' $\frac{1}{2}$ " DEEP VERTICAL — ŚĀW CUT ALL AROUND REMOVE ALL DETERIORATED CONCRETE **EMBEDDED** SEE NOTE 3 (TYP.) TO A DEPTH OF AT LEAST 1" BELOW GALVANIC TOP MAIN REINFORCEMENT AND ANODE REPLACE WITH PATCHING MATERIAL. EXISTING MAIN REINFORCEMENT REINFORCEMENT

#### **DECK PATCHING DETAILS**

- EXISTING

(TYP.)

DISTRIBUTION

REINFORCEMENT

NOTE: SEE DRAWING S-11 FOR EMBEDDED GALVANIC ANODES DETAILS.

**DETAIL - MORTAR BED** 

NOT TO SCALE

MORTAR BED

PARTIAL DEPTH PATCH

REPAIR MATERIAL

		THE INFORMATION, INCLUDING ESTIMATED QUANTITIES OF WORK, SHOWN ON THESE	DESIGNER/DRAFTER:  NRA  CHECKED BY:	CONNECTICAL	SIGNATURE/ BLOCK:  BLOCK:  GRAND OF CONNECONDED  BLOCK OF CONNECON	GM2 ASSOCIATES, INC. 115 GLASTONBURY BLVD. GLASTONBURY, CT 06033  REHABILITATION OF BRIDGE 00728	WESTPORT	PROJECT NO. 158-207
		SHEETS IS BASED ON LIMITED INVESTIGATIONS BY THE STATE AND IS IN NO WAY WARRANTED TO INDICATE THE CONDITIONS OF ACTUAL QUANTITIES	JG	STATE OF CONNECTICUT DEPARTMENT OF TRANSPORTATION	* See See See See See See See See See Se	MERRITT PARKWAY	DRAWING TITLE:	S-23
		OF WORK WHICH WILL BE REQUIRED.	SCALE AS NOTED	DEPARTMENT OF TRANSPORTATION	SENSES OF THE PROPERTY OF THE	OVER SAUGATUCK RIVER	DECK PATCHING	SHEET NO. <b>05.03.23</b>
REV. DATE	REVISION DESCRIPTION SHEET NO.	Plotted Date: 7/6/2016		Filename:\SB_MSH_158-207_DECK_PATCHING.dgn	3000000			33:33:23

1" MIN. REMOVAL BELOW -


TOP MAIN REINFORCING


PARTIAL DEPTH PATCH

SCALE: 1'' = 1'-0''

(TYP.)

SEE NOTE 1

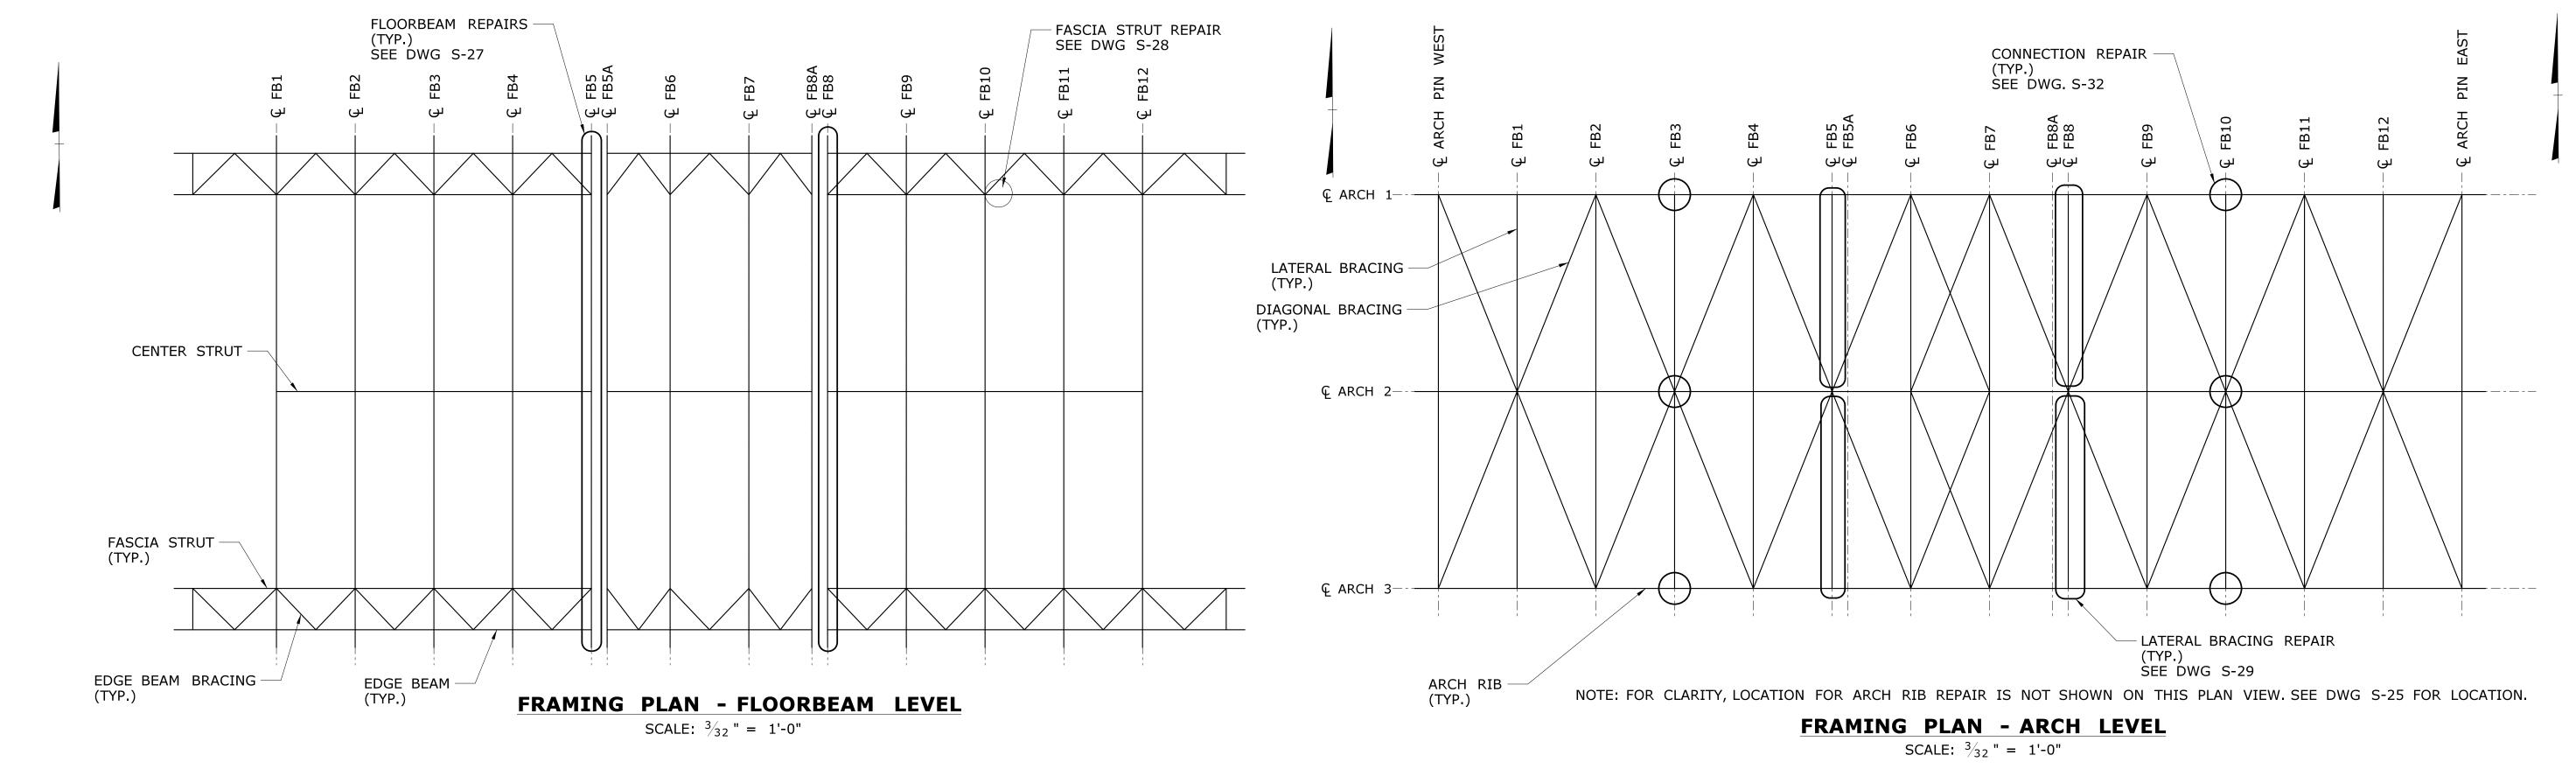


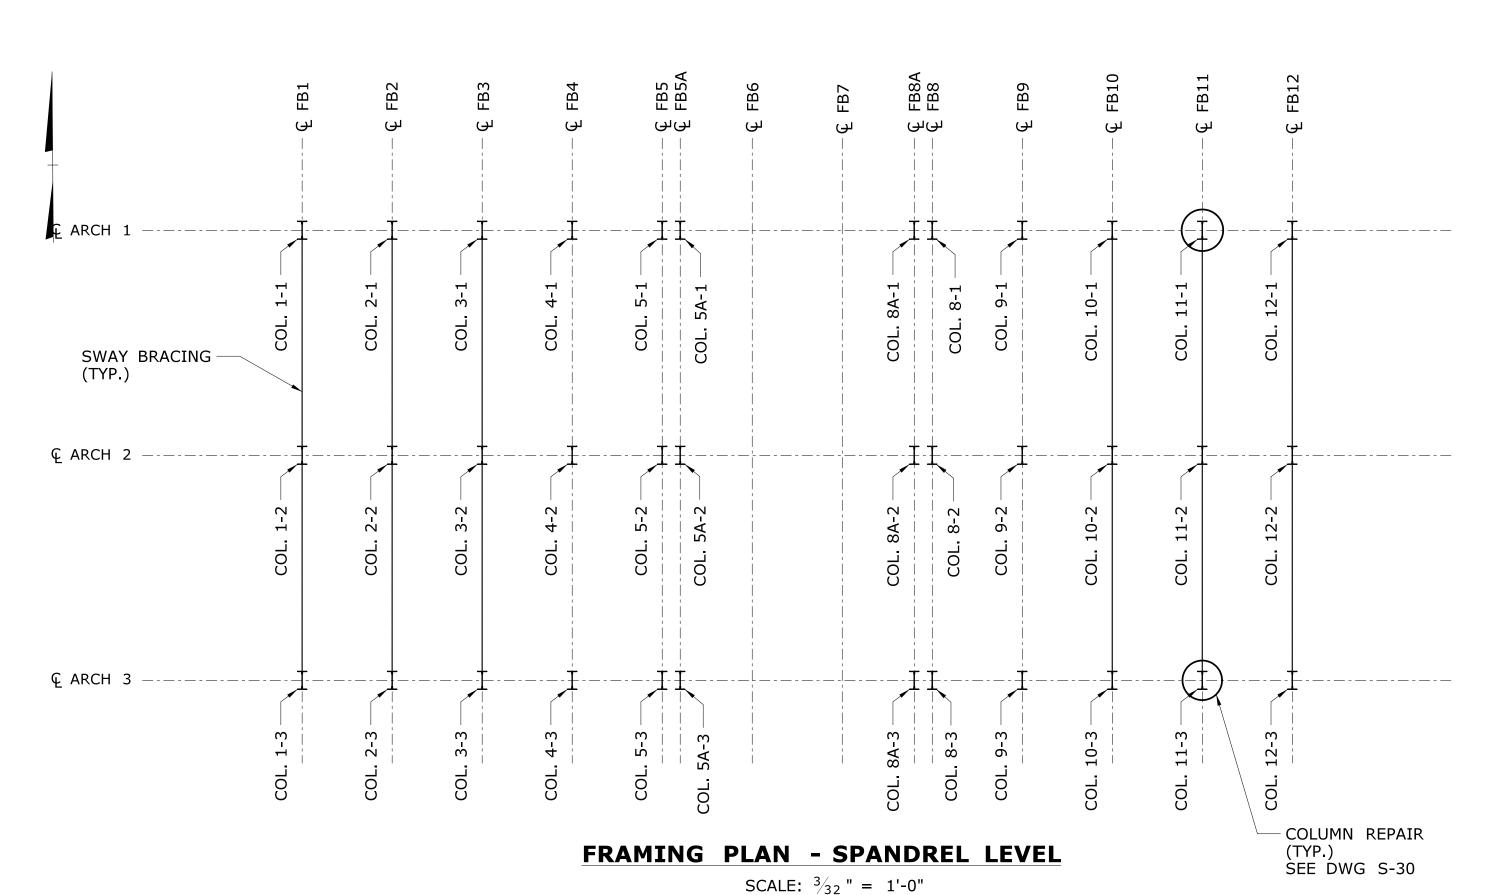



#### STRUCTURAL STEEL NOTES

- 1. ALL STRUCTURAL STEEL SHALL CONFORM TO AASHTO M270 GRADE 50W.
- 2. WELDING DETAILS, PROCEDURES AND TESTING METHODS SHALL CONFORM TO THE CURRENT EDITION OF THE AASHTO/AWS D1.5M/D1.5 BRIDGE WELDING CODE, UNLESS OTHERWISE NOTED ON THE PLANS.
- 3. ALL FIELD WELDS SHALL BE INSPECTED BY THE MAGNETIC PARTICLE METHOD.
- 4. NO ATTACHMENTS OTHER THAN THOSE SHOWN ON THE PLANS SHALL BE FILLET WELDED, PLUG WELDED OR TACK WELDED TO THE EXISTING STEEL.
- 5. THE STRUCTURAL STEEL FABRICATORS SHALL BE CERTIFIED UNDER THE AISC QUALITY CONTROL PROGRAM, CATEGORY MBR, MAJOR STEEL BRIDGES.
- 6. THERE ARE TWO SIZES OF RIVETS IN USE ON THE STRUCTURE. RIVETS ON THE ARCH RIB ARE  $\frac{7}{8}$ " ø AND RIVETS EVERYWHERE ELSE ARE  $\frac{3}{4}$ " ø. THE CONTRACTOR SHALL USE THE CORRECT SIZE BOLT AS NEEDED. REAMING A HOLE FOR A  $\frac{3}{4}$ " ø RIVET TO ACCOMODATE A  $\frac{7}{8}$ " ø BOLT WILL NOT BE ALLOWED.
- 7. ALL NEW BOLTS SHALL BE  $^{7}/_{8}$ " DIA. HIGH STRENGTH BOLTS IN  $^{15}/_{16}$ " DIA. HOLES ON THE ARCH RIB MEMBERS AND  $^{3}/_{4}$ " DIA. BOLTS WITH  $^{13}/_{16}$ " DIA. HOLES ELSEWHERE, EXCEPT AS NOTED AND SHALL CONFORM TO THE REQUIREMENTS OF ASTM A325 TYPE 1.
- 8. PRIOR TO INSTALLATION OF ANY REPAIR PLATES, THE SURFACES IN CONTACT SHALL BE PREPARED IN ACCORDANCE WITH THE SPECIAL PROVISION HRCSA CORROSION PROTECTION SYSTEM AND THE PENETRANT SEALER APPLIED TO BOTH CONTACT SURFACES PRIOR TO INSTALLATION OF ANY REPAIRS.
- 9. THE LOCATION OF THE EXISTING RIVETS SHALL BE TRANSFERRED TO THE PROPOSED STEEL USING TEMPLATES.
- 10. ALL HOLES IN THE NEW STEEL SHALL BE SUB-DRILLED (OR SUB-PUNCHED) TO  $^{15}/_{16}$  " DIA. ON THE ARCH RIB AND  $\frac{13}{16}$ " DIA. ELSEWHERE, EXCEPT AS NOTED.
- 11. ALL NEW HOLES IN PROPOSED STEEL WHERE THERE ARE EXISTING RIVETS/ BOLTS SHALL BE LOCATED USING A TEMPLATE MADE FROM THE EXISTING STEEL AND HOLES SUBDRILLED.
- 12. IN LOCATIONS WHERE THERE IS NO EXISTING RIVET, THE HOLES SHALL BE SUB-DRILLED.
- 11. THE CONTRACTOR SHALL CAREFULLY REMOVE THE RIVET HEADS WHICH INTEREFERE WITH THE INSTALLATION OF THE REPAIR PLATES. REMOVAL SHALL UTILIZE A LIGHT CHIPPING HAMMER WITH AN APPROPRIATE ATTACHMENT OR GRINDING. BURNING WILL NOT BE ALLOWED. THE CONTRACTOR SHALL TAKE CARE NOT TO DAMAGE THE EXISTING STEEL. ANY DAMAGE SHALL BE REPAIRED USING A PROCEDURE APPROVED BY THE ENGINEER.
- 12. THE CONTRACTOR SHALL TAKE PROPER PRECAUTIONS TO ENSURE THE STABILITY OF ALL STRUCTURAL ELEMENTS UNTIL THE TOTAL STRUCTURE IS IN BEING.

		THE INFORMATION, INCLUDING ESTIMATED QUANTITIES OF WORK, SHOWN ON THESE	DESIGNER/DRAFTER:  SC/NRA  CHECKED BY:	CONNECTICITY OF THE PROPERTY O	SIGNATURE/ BLOCK:	GM2 ASSOCIATES, INC. 115 GLASTONBURY BLVD GLASTONBURY, CT 06033  PROJECT TITLE:  REHABILITATION OF BRIDGE 00728	TOWN: WESTPORT	PROJECT NO. 158-207
		SHEETS IS BASED ON LIMITED INVESTIGATIONS BY THE STATE AND IS IN NO WAY WARRANTED TO INDICATE THE CONDITIONS OF ACTUAL QUANTITIES	JG	DEPARTMENT OF TRANSPORTATION	The contract of the contract o	MERRITT PARKWAY	DRAWING TITLE:	DRAWING NO.  S-24
		OF WORK WHICH WILL BE REQUIRED.	SCALE AS NOTED	DEPARTMENT OF TRANSPORTATION	SENSE SONAL ENGLISH	OVER SAUGATUCK RIVER	STEEL FRAMING PLAN	SHEET NO. <b>05.03.24</b>
REV. DATE	REVISION DESCRIPTION SHEET NO.	Plotted Date: 7/6/2016		Filename:\SB_MSH_158-207_FRAMING_PLAN.dgn	- Million			00.00.2

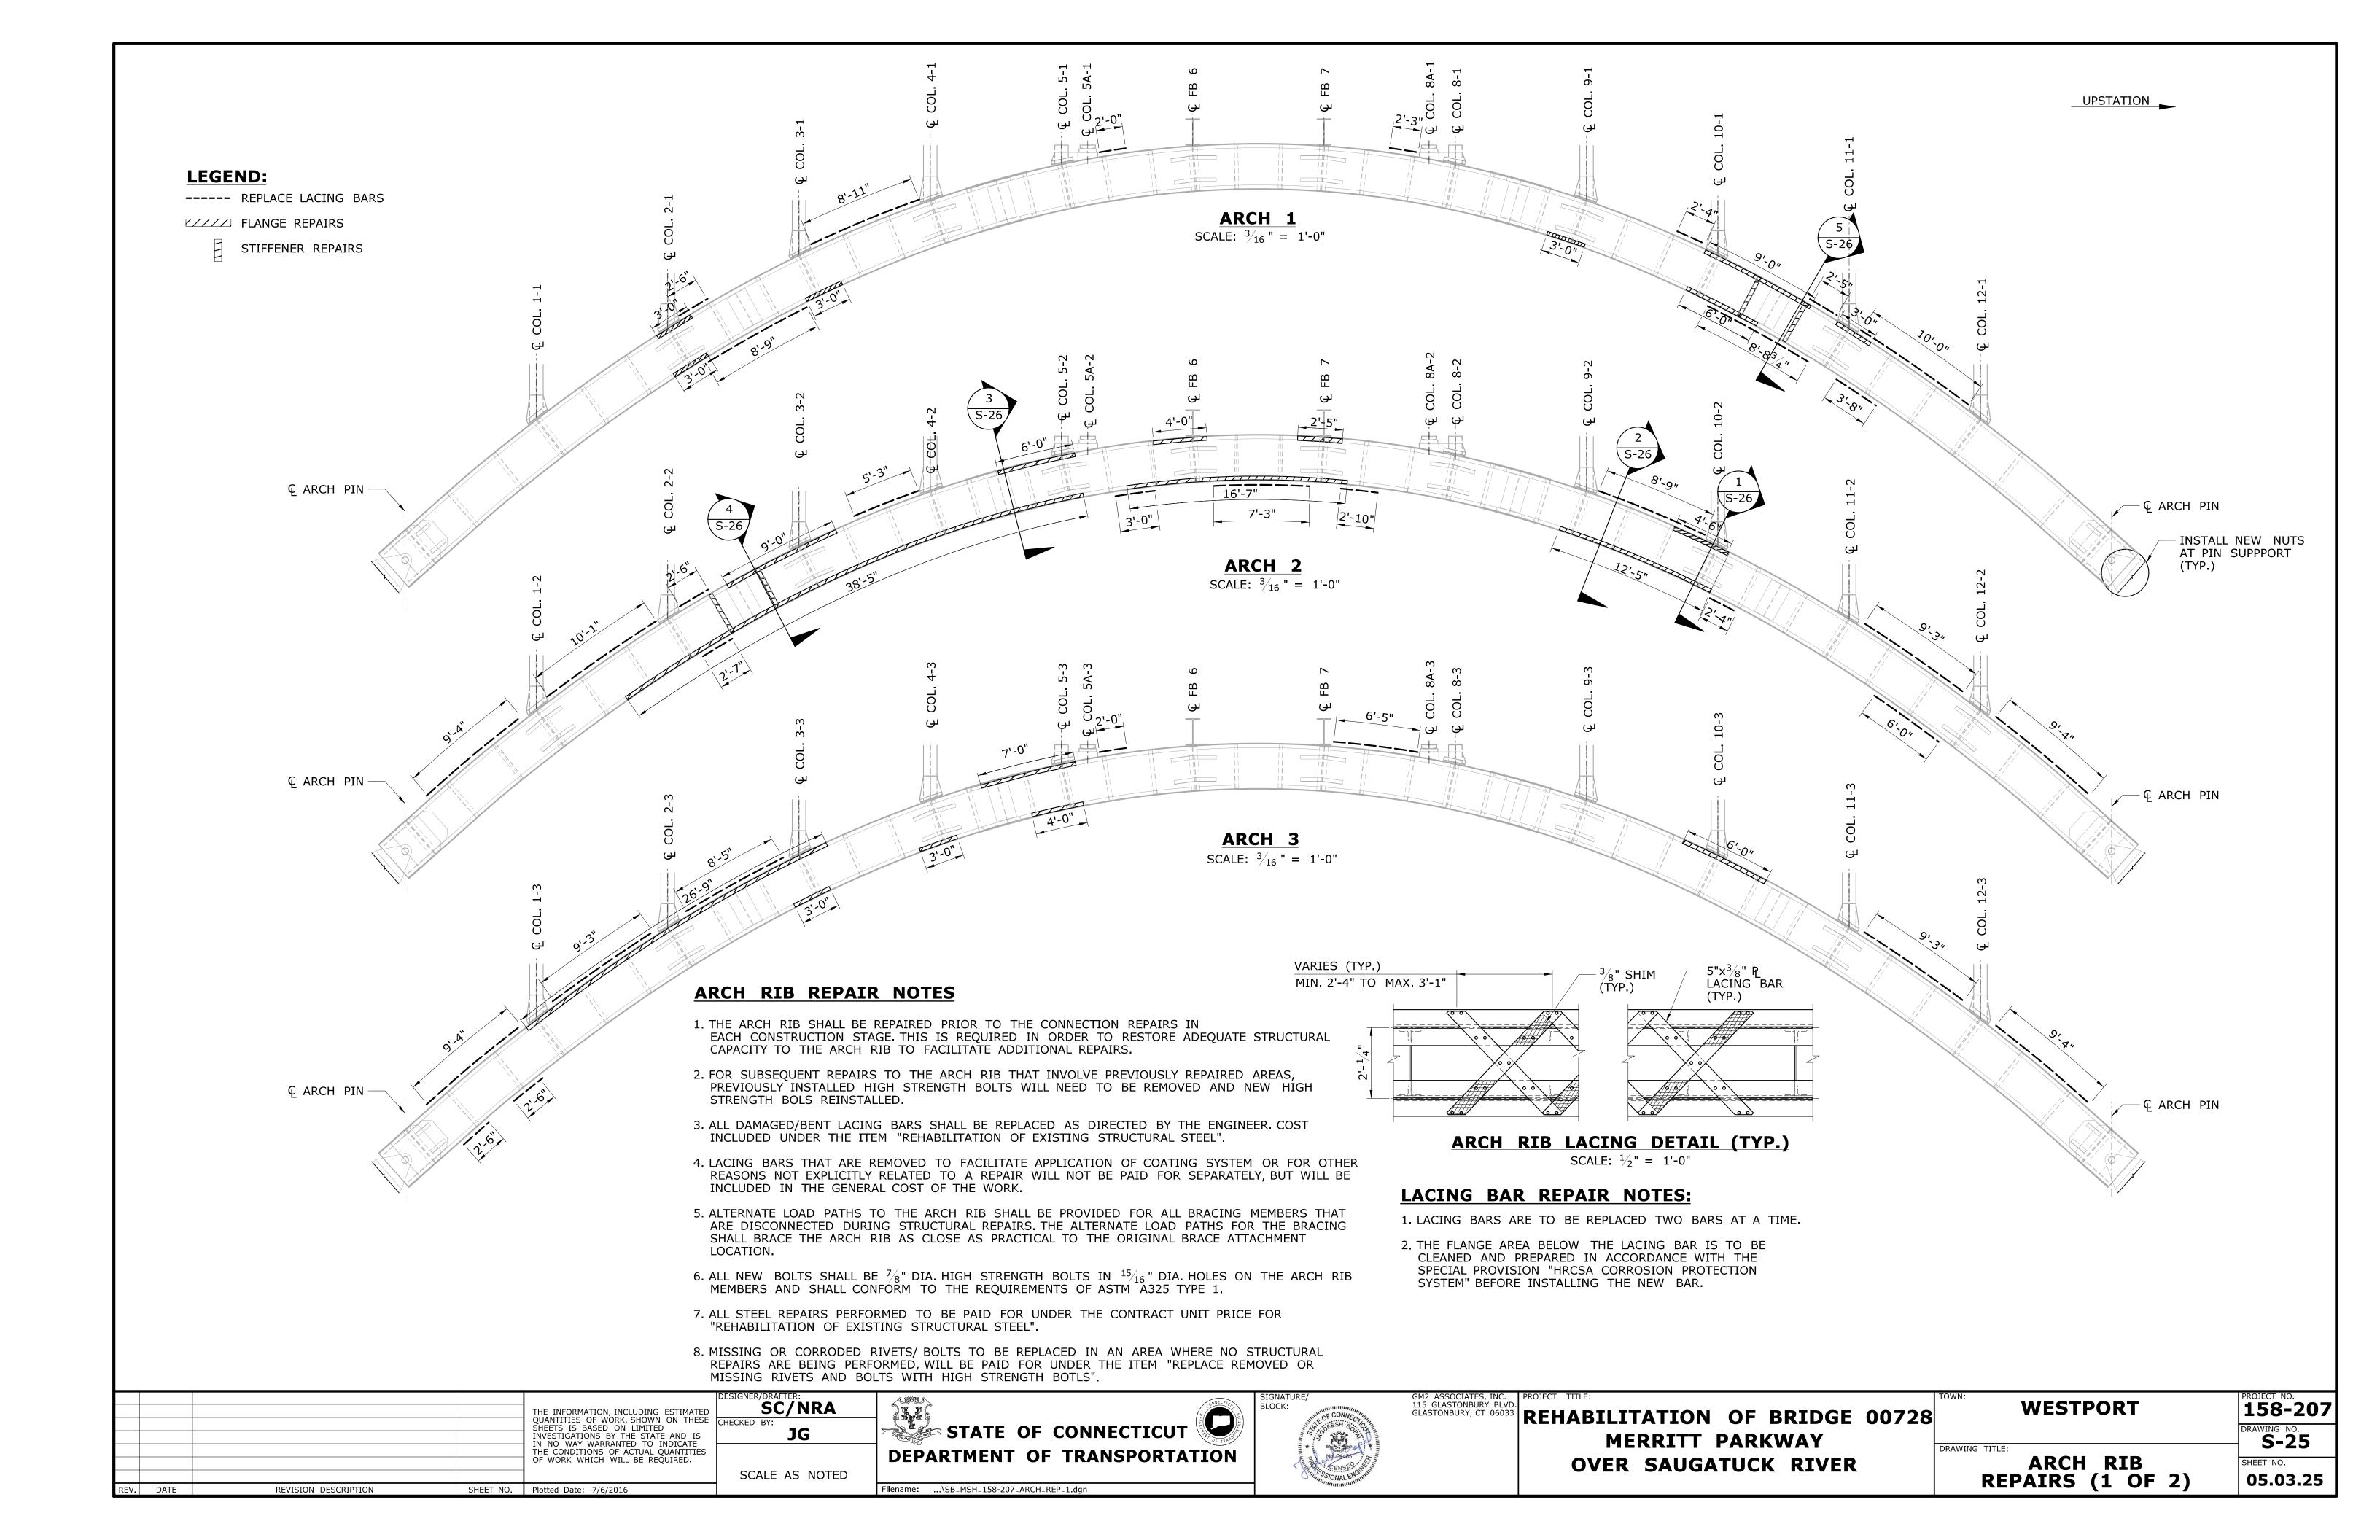


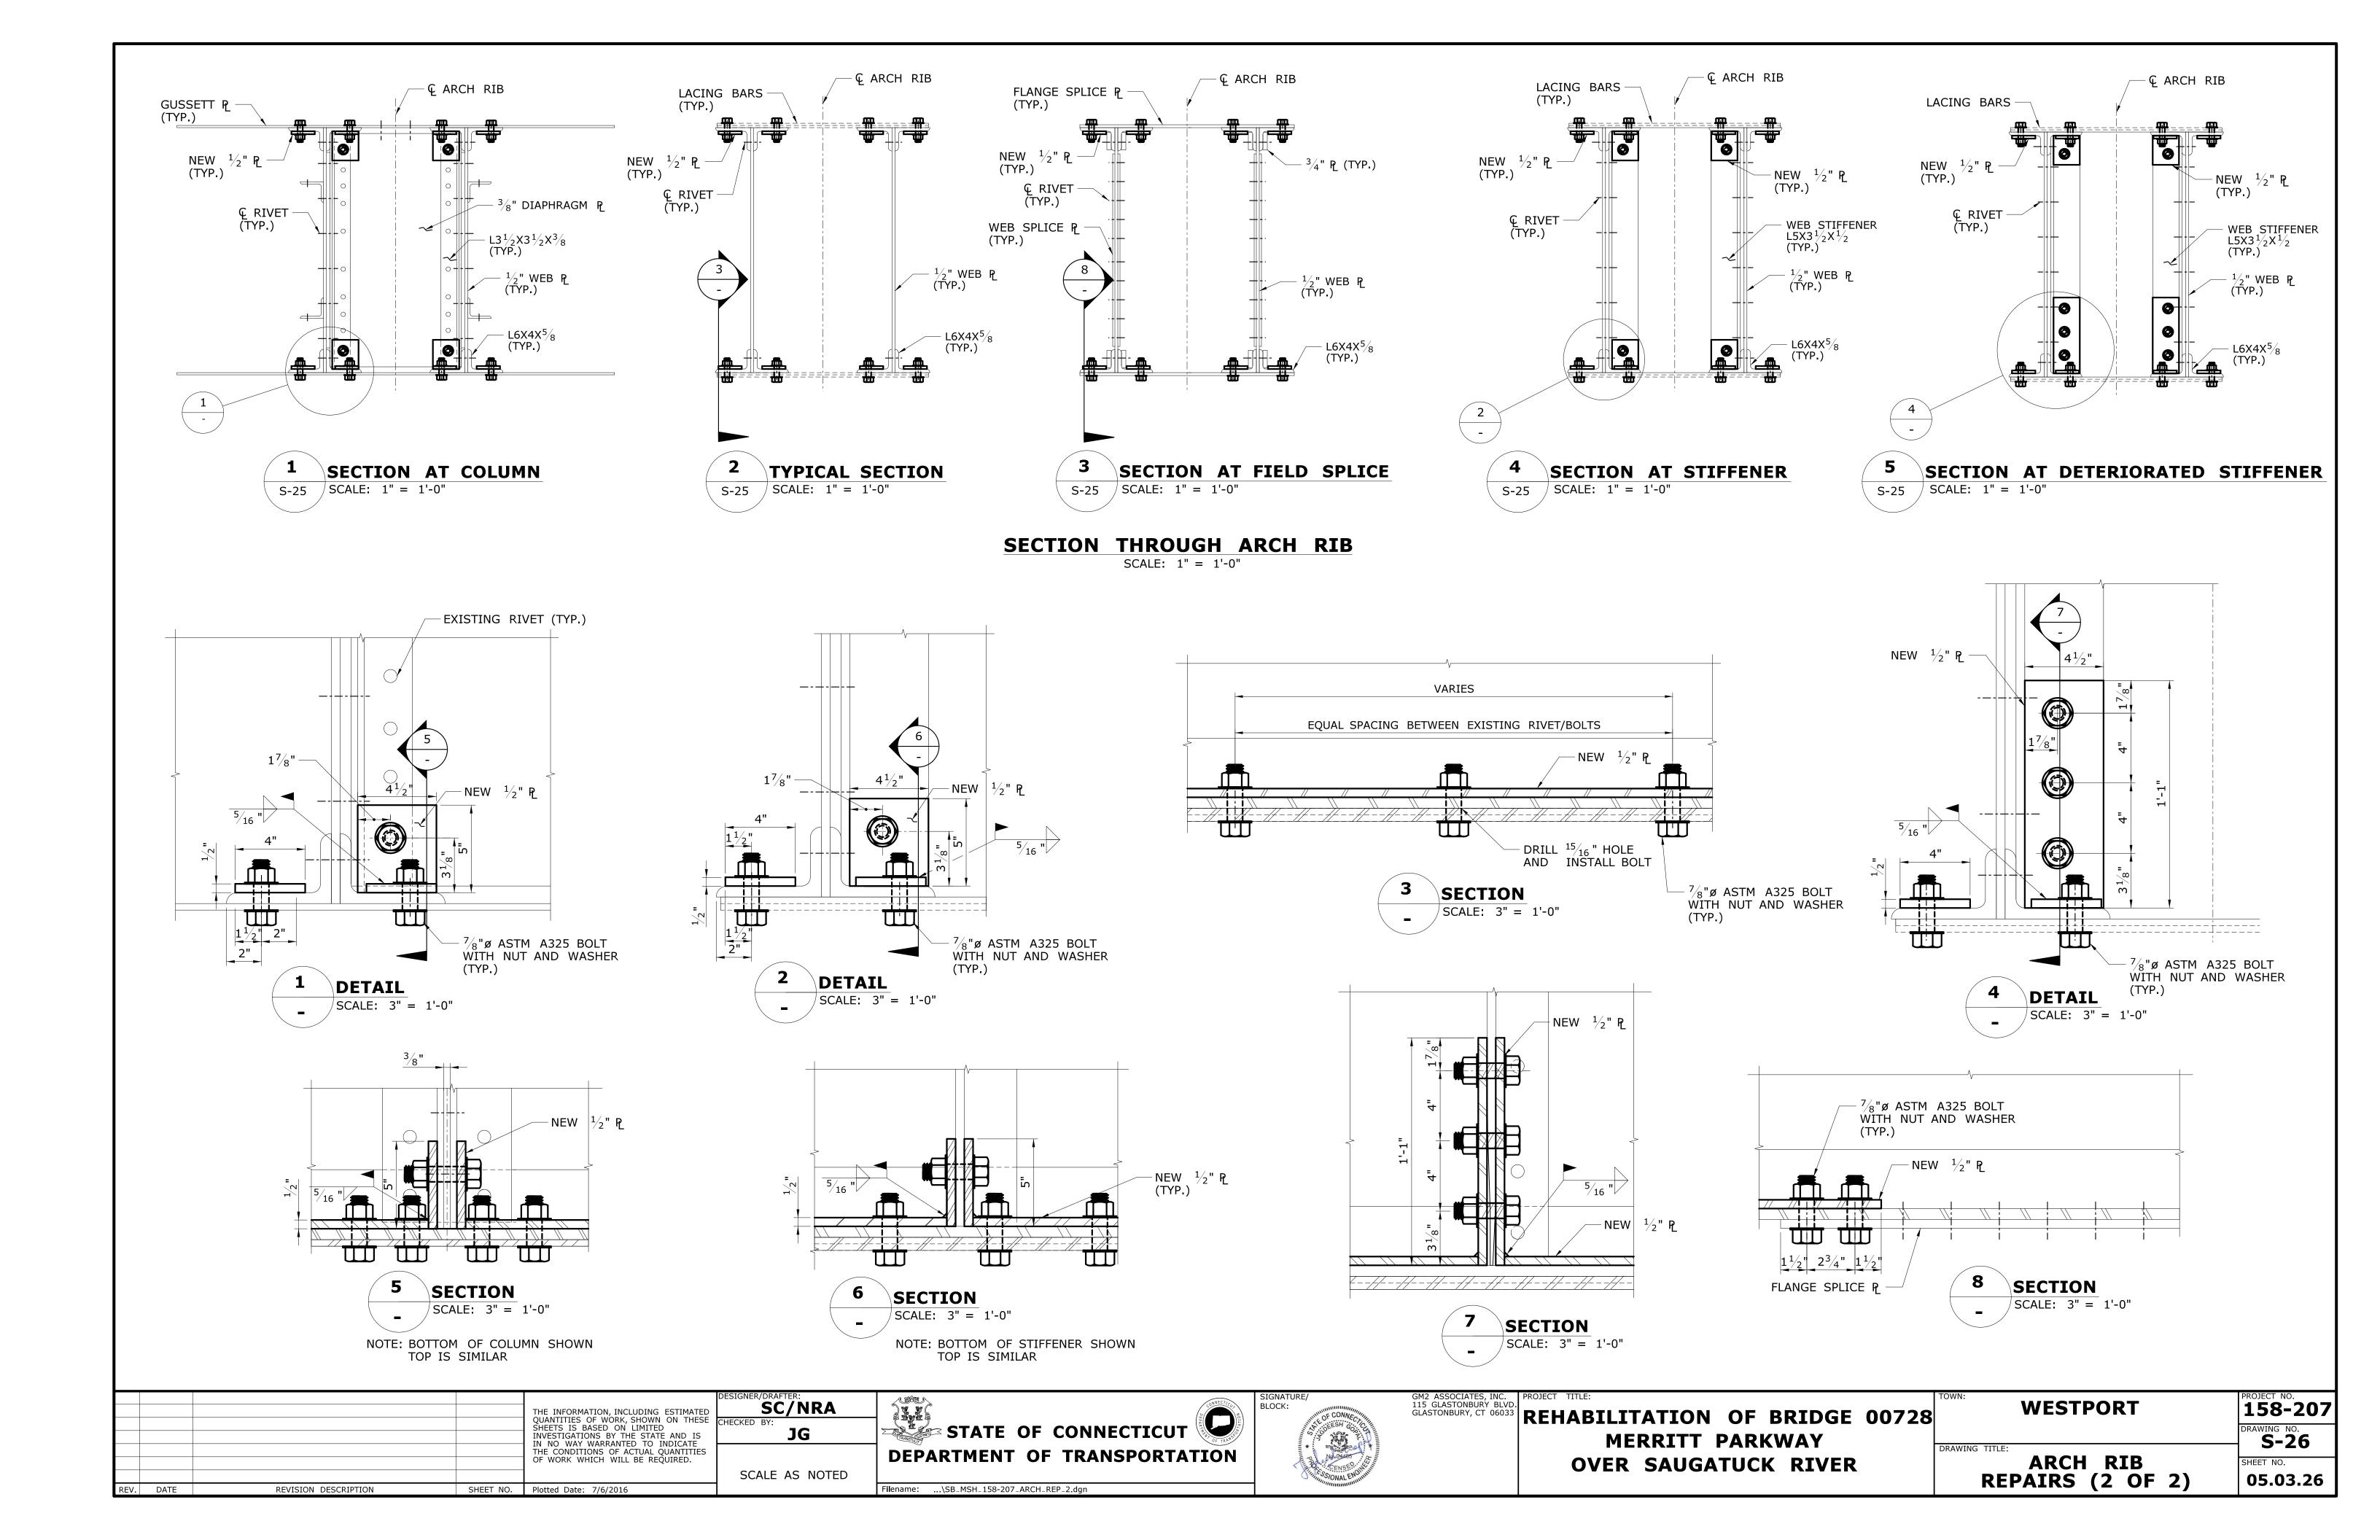

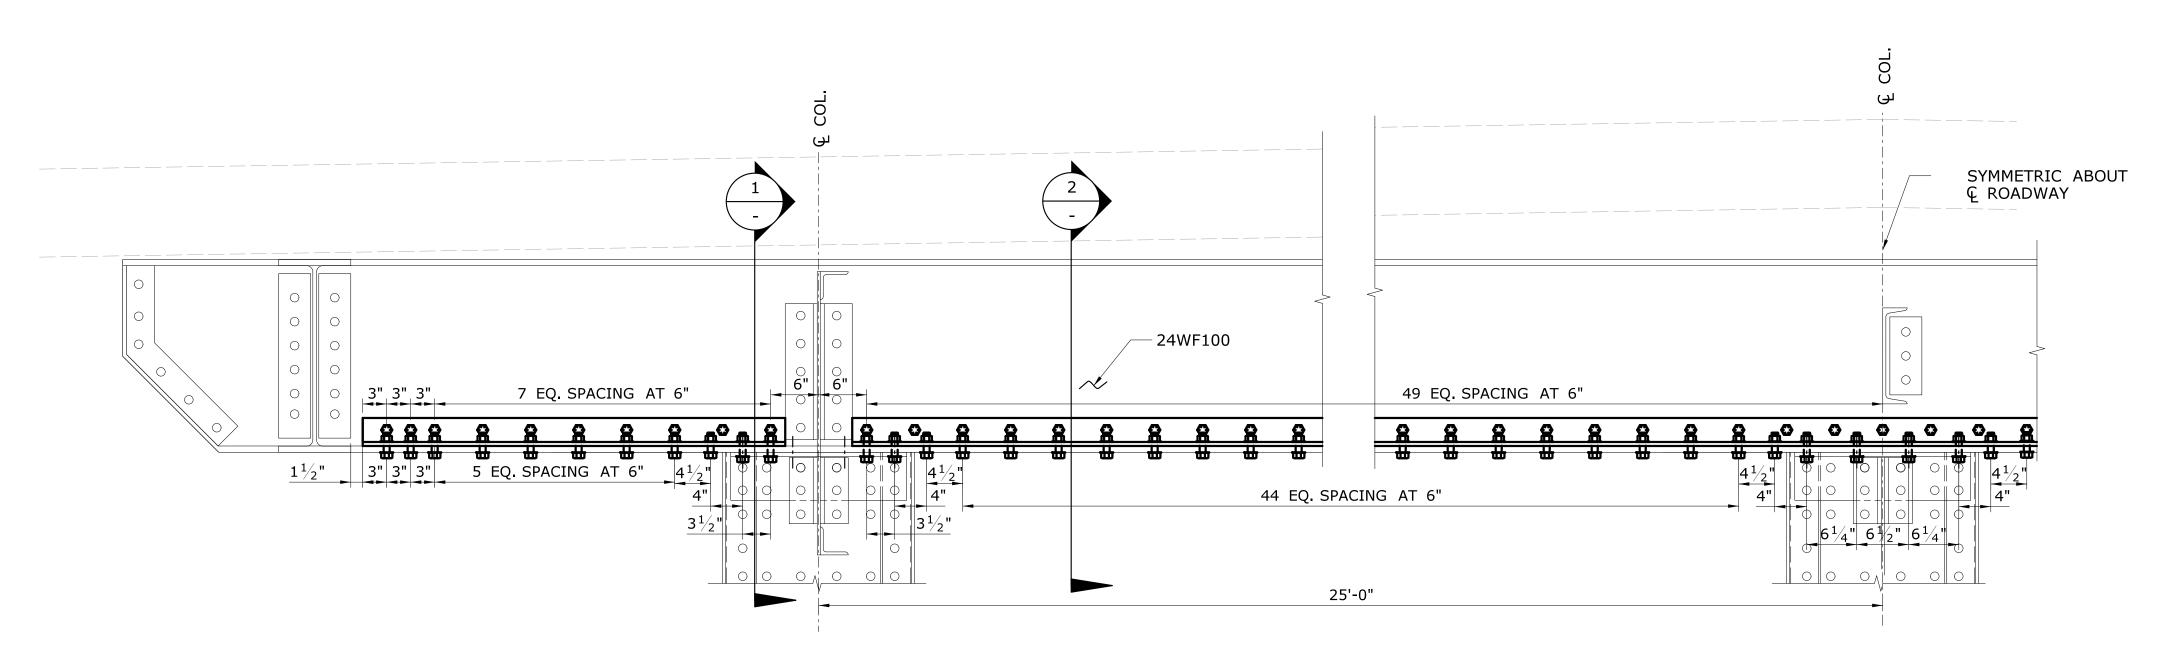

#### FLOORBEAM ELEVATION

NOTE: FLOORBEAM 5 SHOWN. FLOORBEAM 8 SIMILAR.

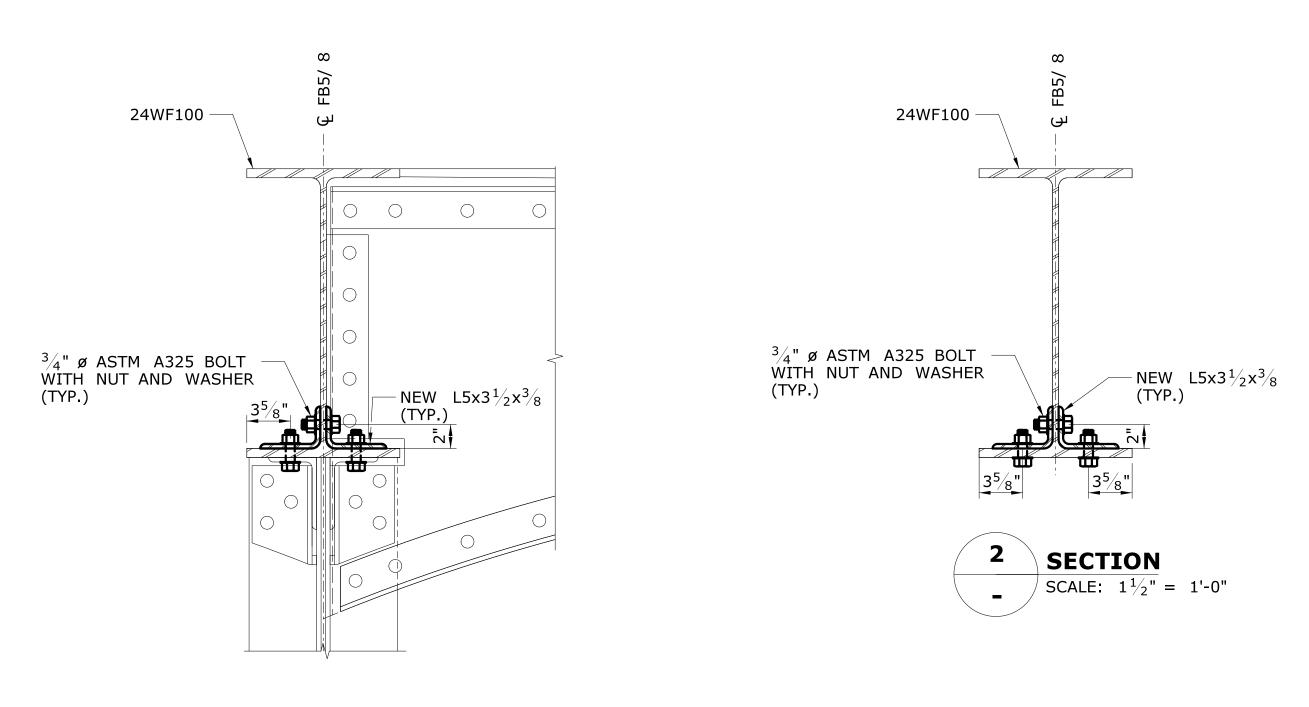


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SCALE:  $1\frac{1}{2}$ " = 1'-0"

#### **NOTES:**


- 1. FLOORBEAMS 5 & 8 SHALL BE REPAIRED.
- 2. NEW ANGLE MEMBERS SHALL BE GROUND TO CLEAR FILLET AS REQUIRED.

THE INFORMATION, INCLUDING ESTIMATED QUANTITIES OF WORK, SHOWN ON THESE	DESIGNER/DRAFTER:  NRA  CHECKED BY:	CONNECTICAL ASSESSMENT OF THE PROPERTY OF THE	SIGNATURE/ BLOCK:  OF CONNECTION  OF	GM2 ASSOCIATES, INC. 115 GLASTONBURY BLVD GLASTONBURY, CT 06033  REHABILITATION OF BRIDGE 00728	WESTPORT	PROJECT NO. <b>158-207</b>
INVESTIGATIONS BY THE STATE AND IS IN NO WAY WARRANTED TO INDICATE THE CONDITIONS OF ACTUAL QUANTITIES	JG	DEPARTMENT OF TRANSPORTATION	No 24485	MERRITT PARKWAY	DRAWING TITLE:	S-27
DEV. DATE REVISION DESCRIPTION SHEET NO Plotted Date: 7/6/2016	SCALE AS NOTED	Filename: \SR MSH 158-207 FLOODREAM dan	CENSED THE	OVER SAUGATUCK RIVER	FLOORBEAM REPAIRS	SHEET NO. <b>05.03.27</b>

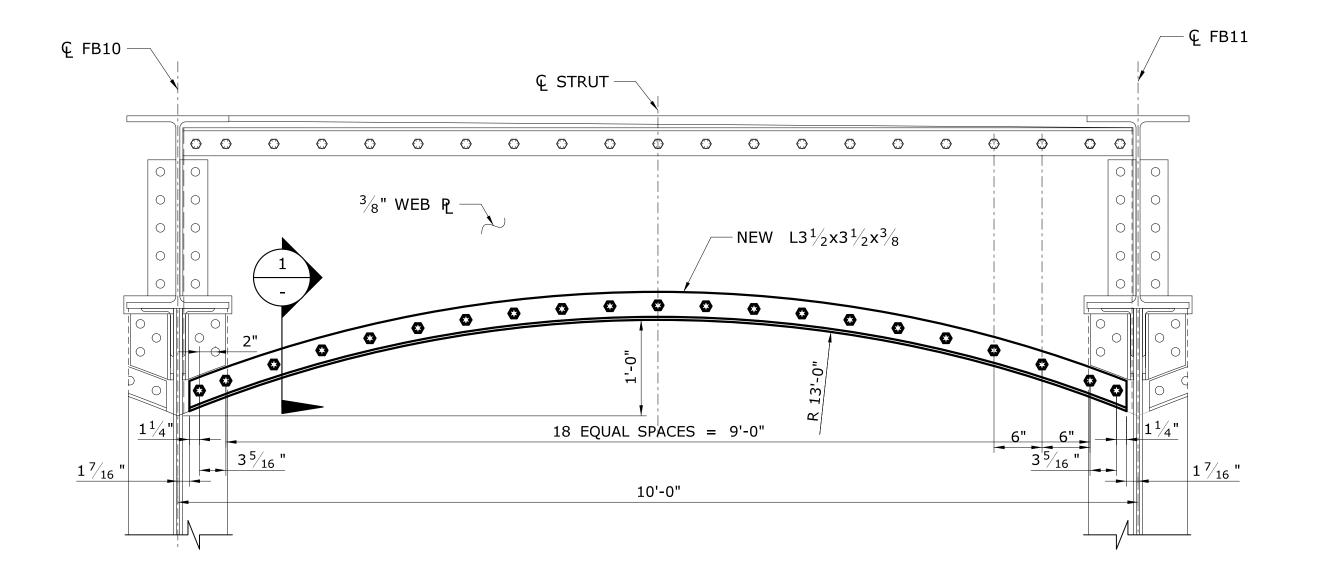

FASCIA STRUT REPAIR DETAILS (ARCH 1)

SCALE: 1" = 1'-0"

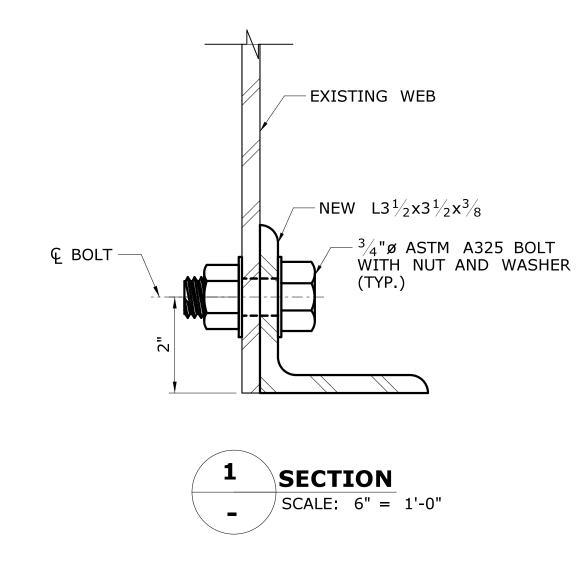


PROJECT NO. 158-207 DRAWING NO. 5-28


SHEET NO. **05.03.28** 

#### **NOTES:**

1. STRUT LOCATED ON EAST SIDE OF FLOOR BEAM 10 SHALL BE REPAIRED.


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IN NO WAY WARRANTED TO INDICATE THE CONDITIONS OF ACTUAL QUANTITIES OF WORK WHICH WILL BE REQUIRED.	SCALE AS NOTED	DEPARTMENT OF TRANSPORTATION  Filename: \SB MSH 158-207 FASCIA STRUT dan	NO 23085	OVER SAUGATUCK RIVER	FASCIA STRUT REPAIR

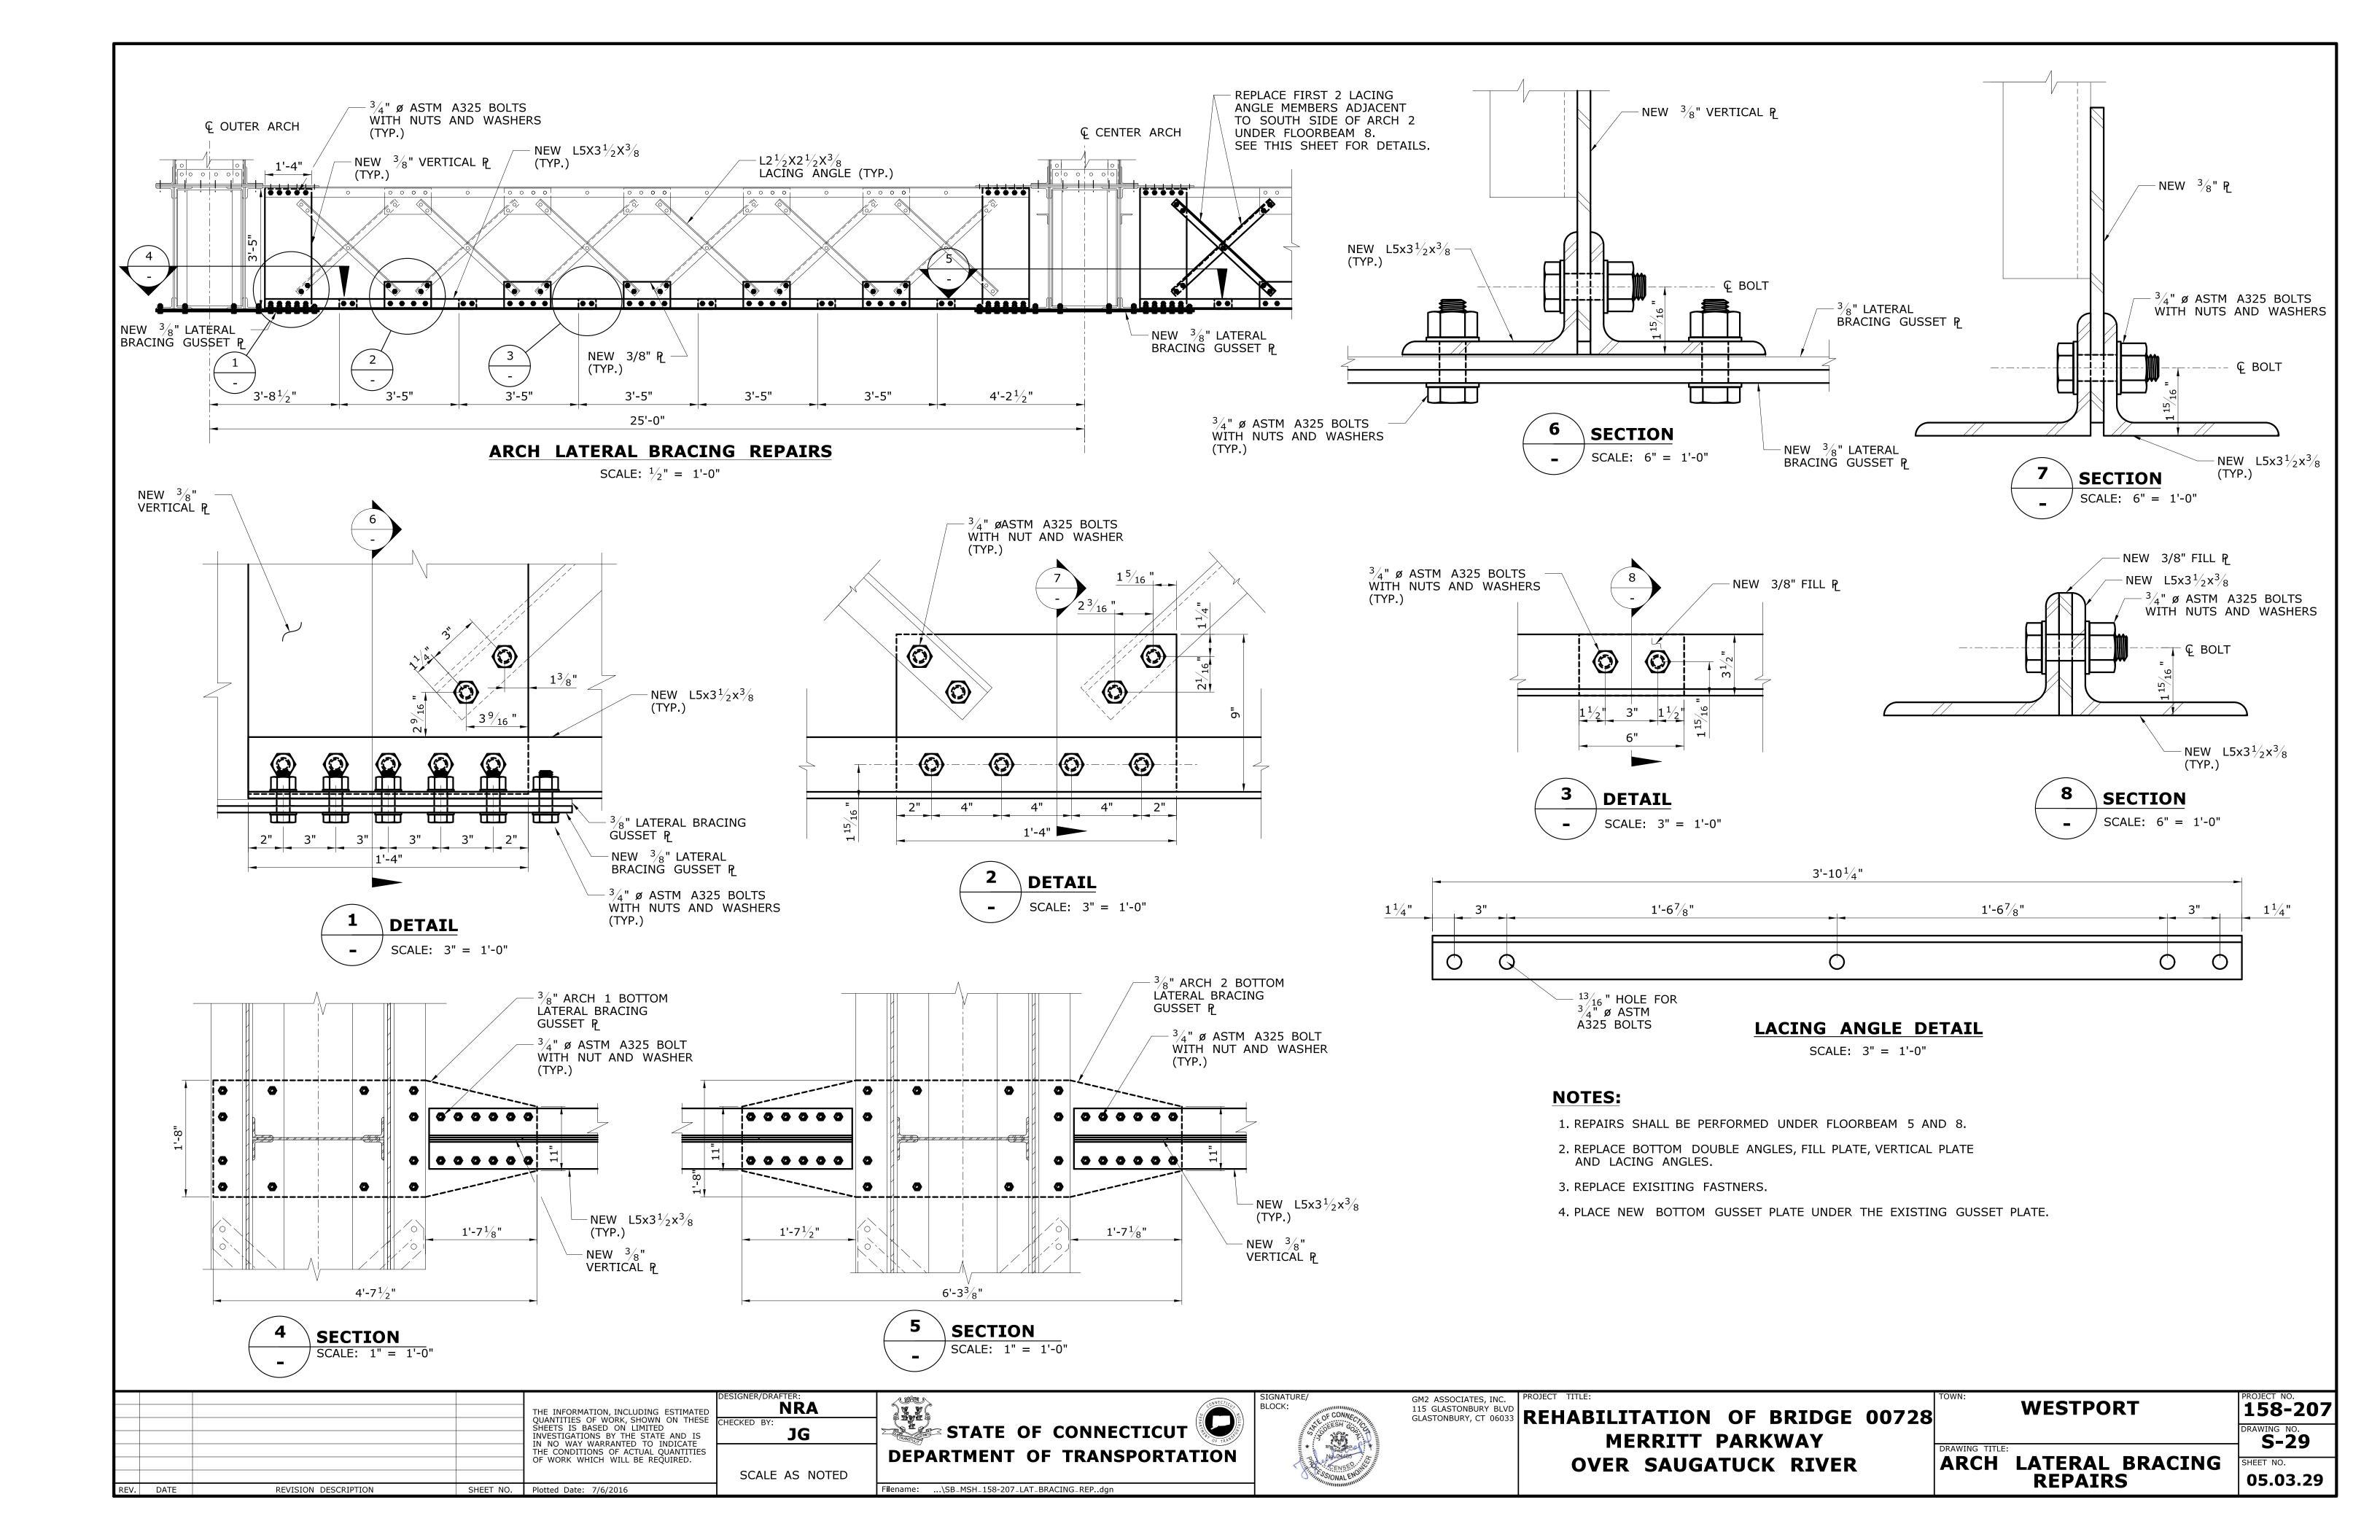

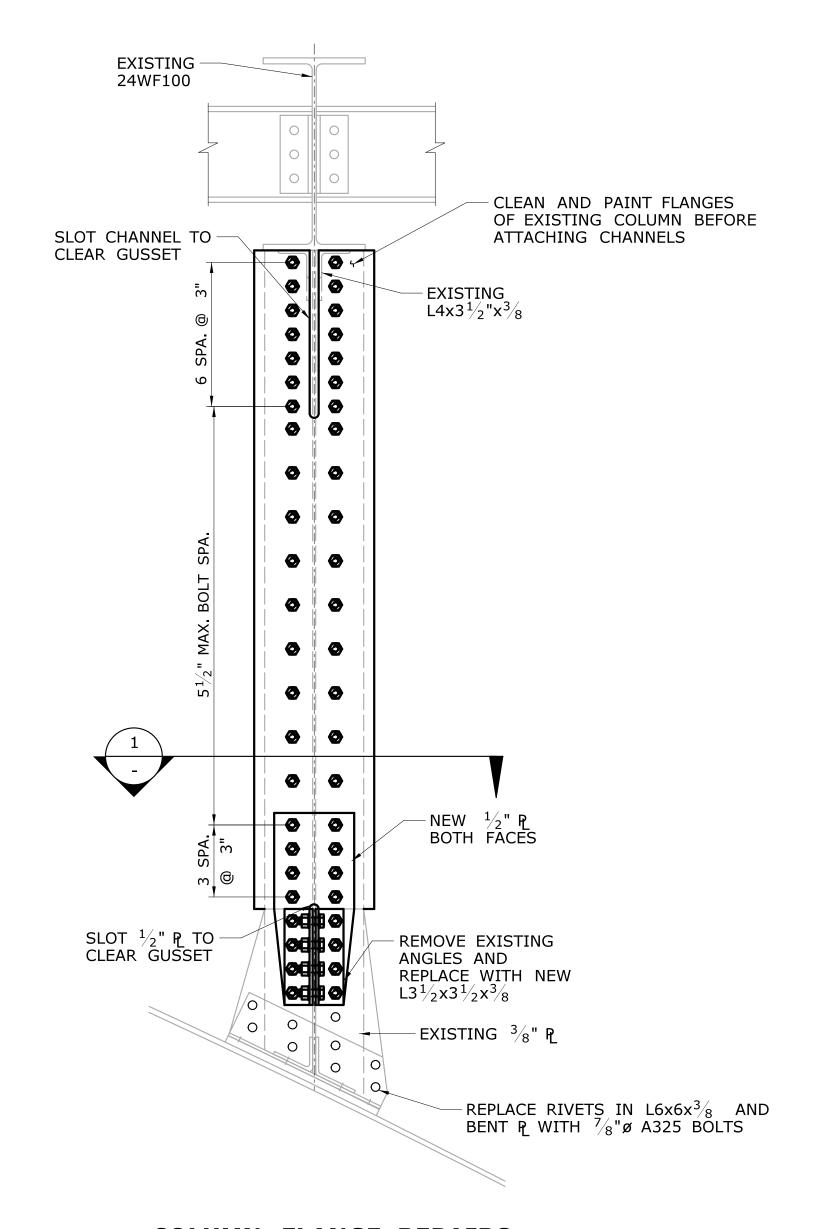

**COLUMN FLANGE REPAIRS** 

SCALE: 1" = 1'-0"

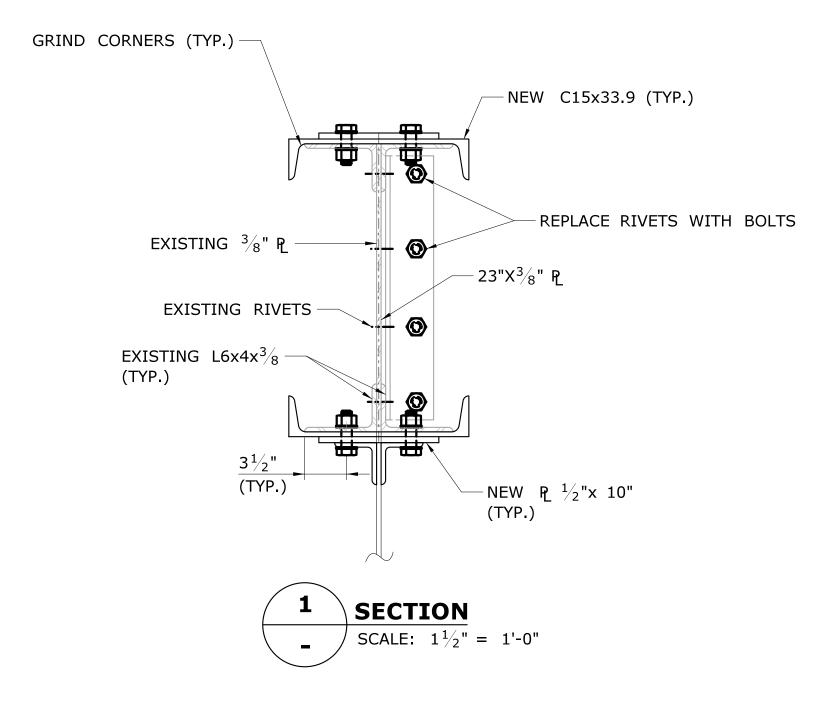

#### **NOTES:**

- 1. THE SPANDREL COLUMNS SHALL BE REPAIRED PRIOR TO STAGE CONSTRUCTION.
- 2. COLUMN 11-1 AND 11-3 ARE TO BE REPAIRED.
- 3. REPAIR IS TO BE COMPLETED ON ONE SIDE OF COLUMN BEFORE BEGINNING WORK ON OTHER SIDE.
- 4. ALL BOLTS ARE TO BE  $\frac{7}{8}$ " DIA. ASTM A325.

					DESIGNER/DRAFTER:
				THE INFORMATION, INCLUDING ESTIMATED	NRA
				QUANTITIES OF WORK, SHOWN ON THESE SHEETS IS BASED ON LIMITED INVESTIGATIONS BY THE STATE AND IS	CHECKED BY:
				IN NO WAY WARRANTED TO INDICATE THE CONDITIONS OF ACTUAL QUANTITIES OF WORK WHICH WILL BE REQUIRED.	
				OF WORK WHICH WILL BE REQUIRED.	SCALE AS NOTED
REV.	DATE	REVISION DESCRIPTION	SHEET NO.	Plotted Date: 7/6/2016	1







M2 ASSOCIATES, INC. L5 GLASTONBURY BLVD.	
LASTONBURY, CT 06033	REHABILITATION
	MERRITT
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<b>:</b>	TOWN:
BILITATION OF BRIDGE 00728	
MERRITT PARKWAY	
	DRAWI
VER SAUGATUCK RIVER	

WESTPORT	158-207
VING TITLE:	DRAWING NO. <b>S-30</b>
COLUMN REPAIRS	SHEET NO. <b>05.03.30</b>



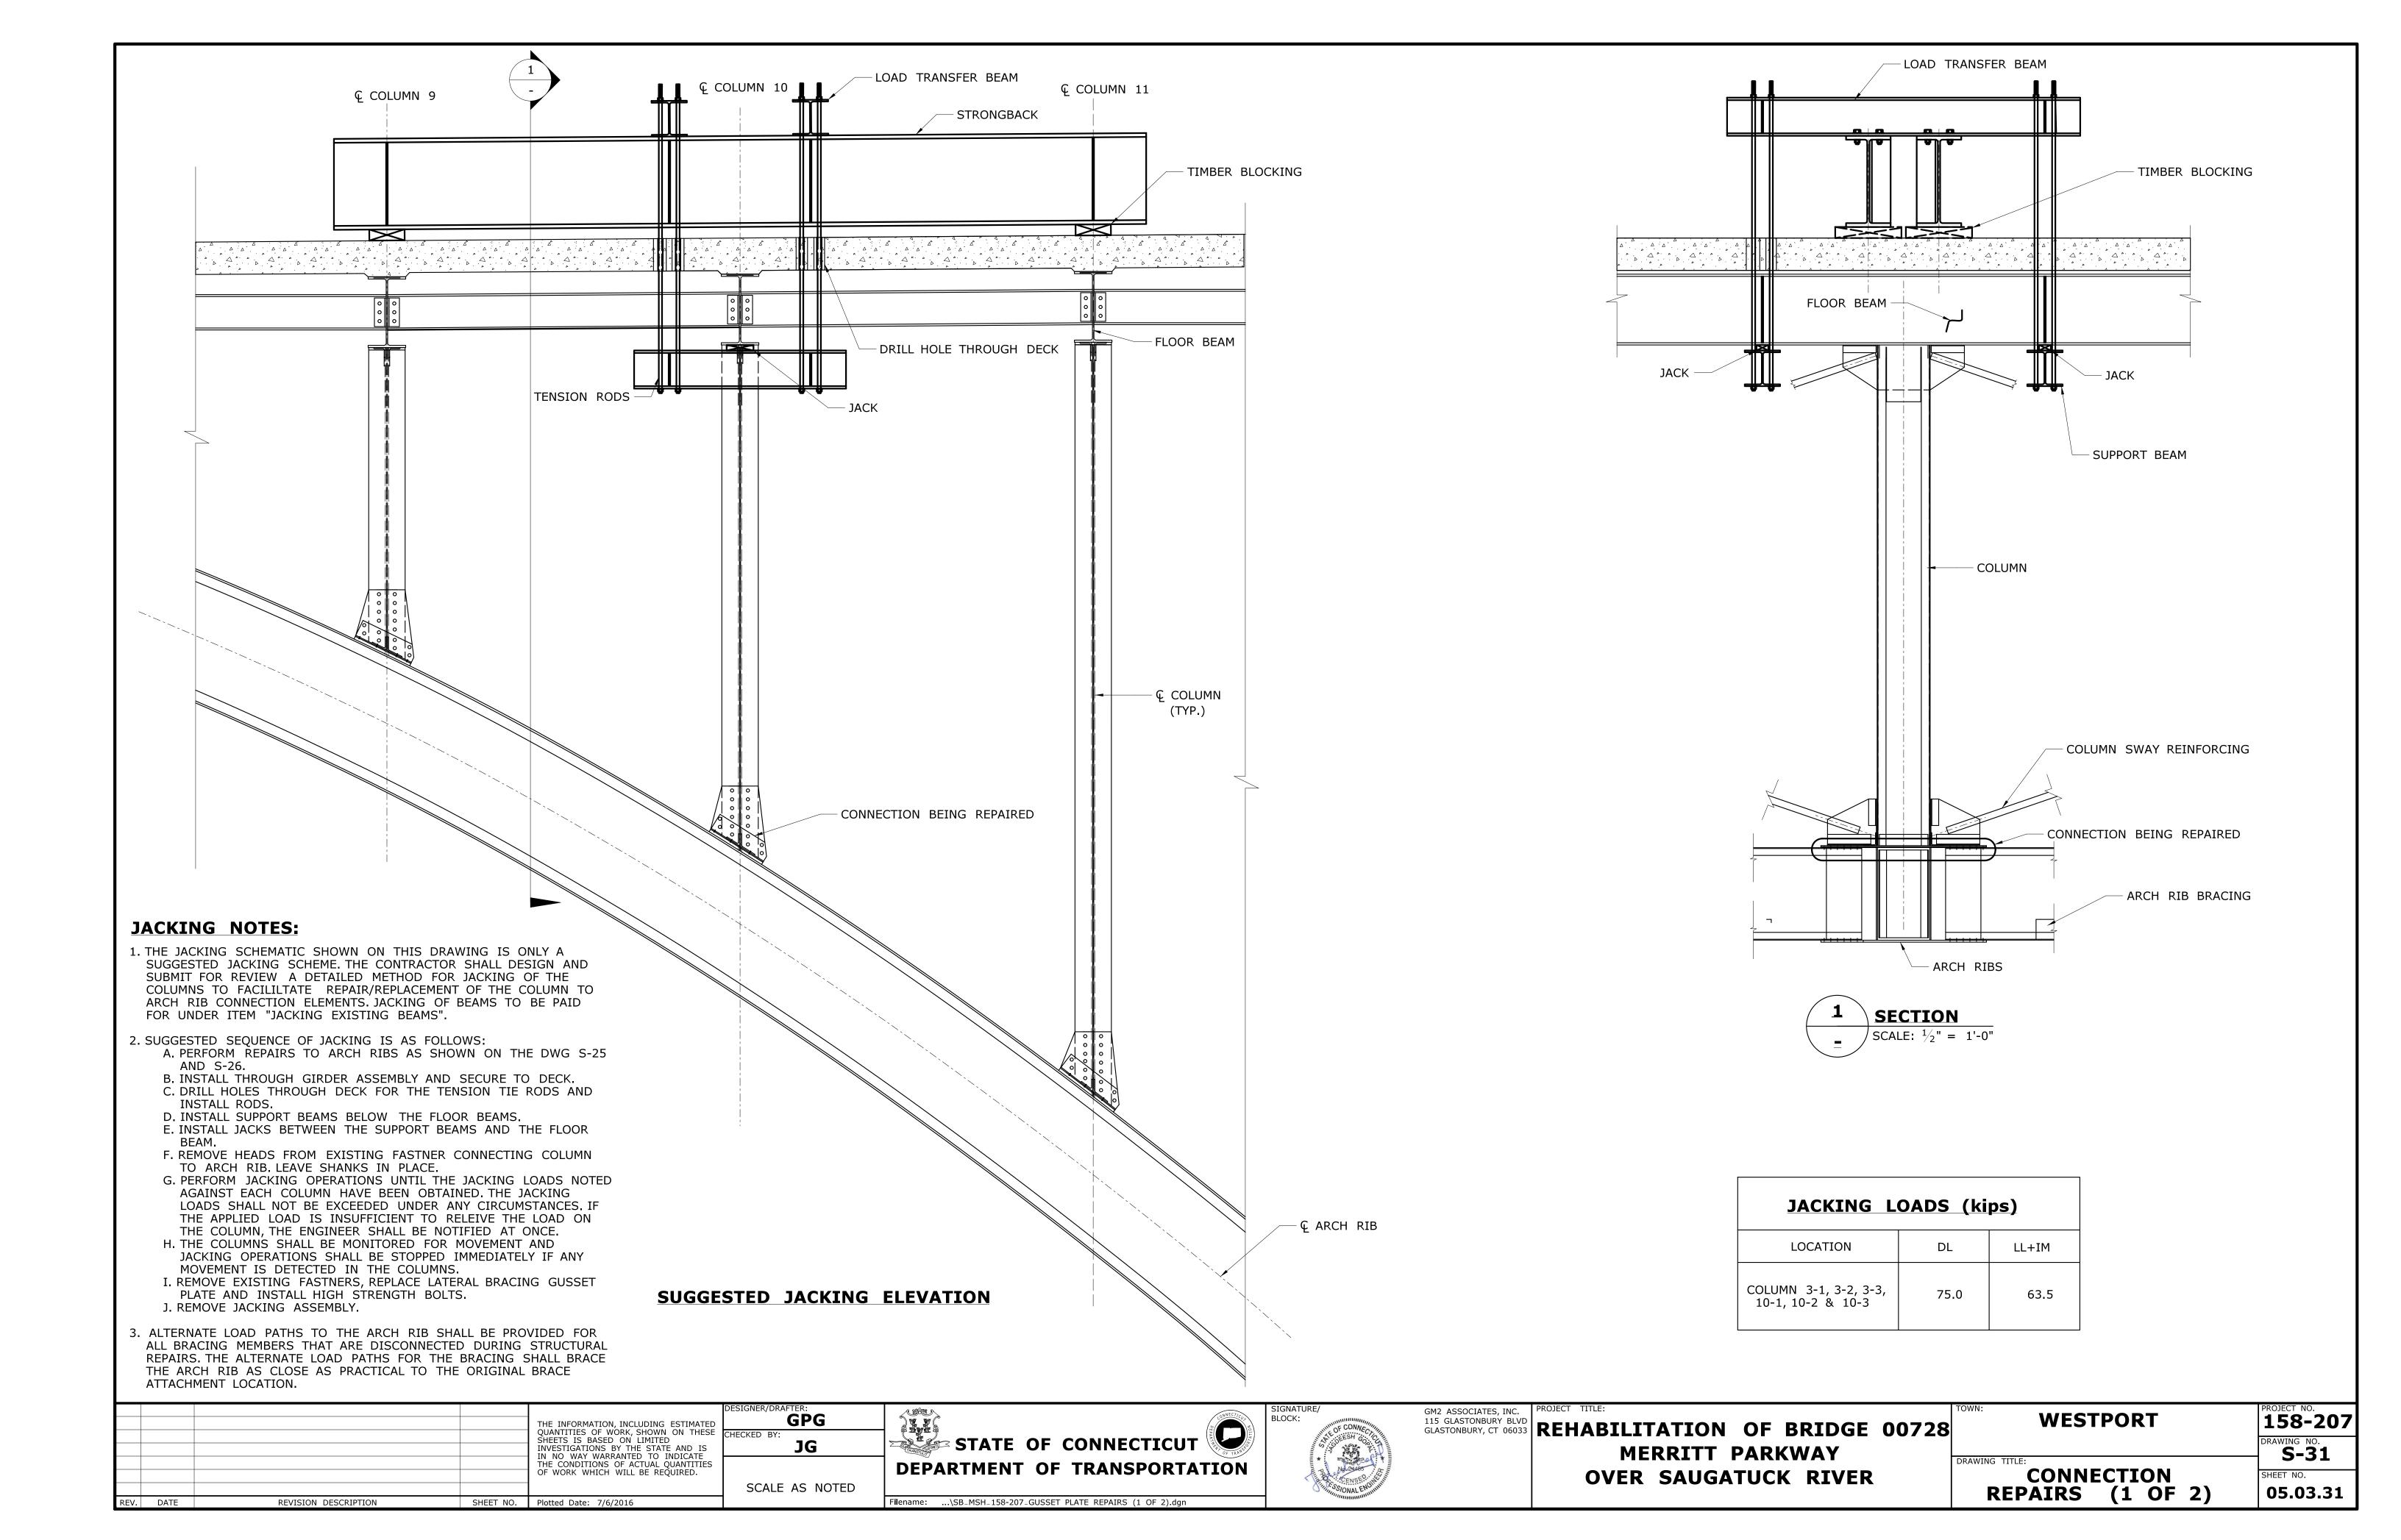

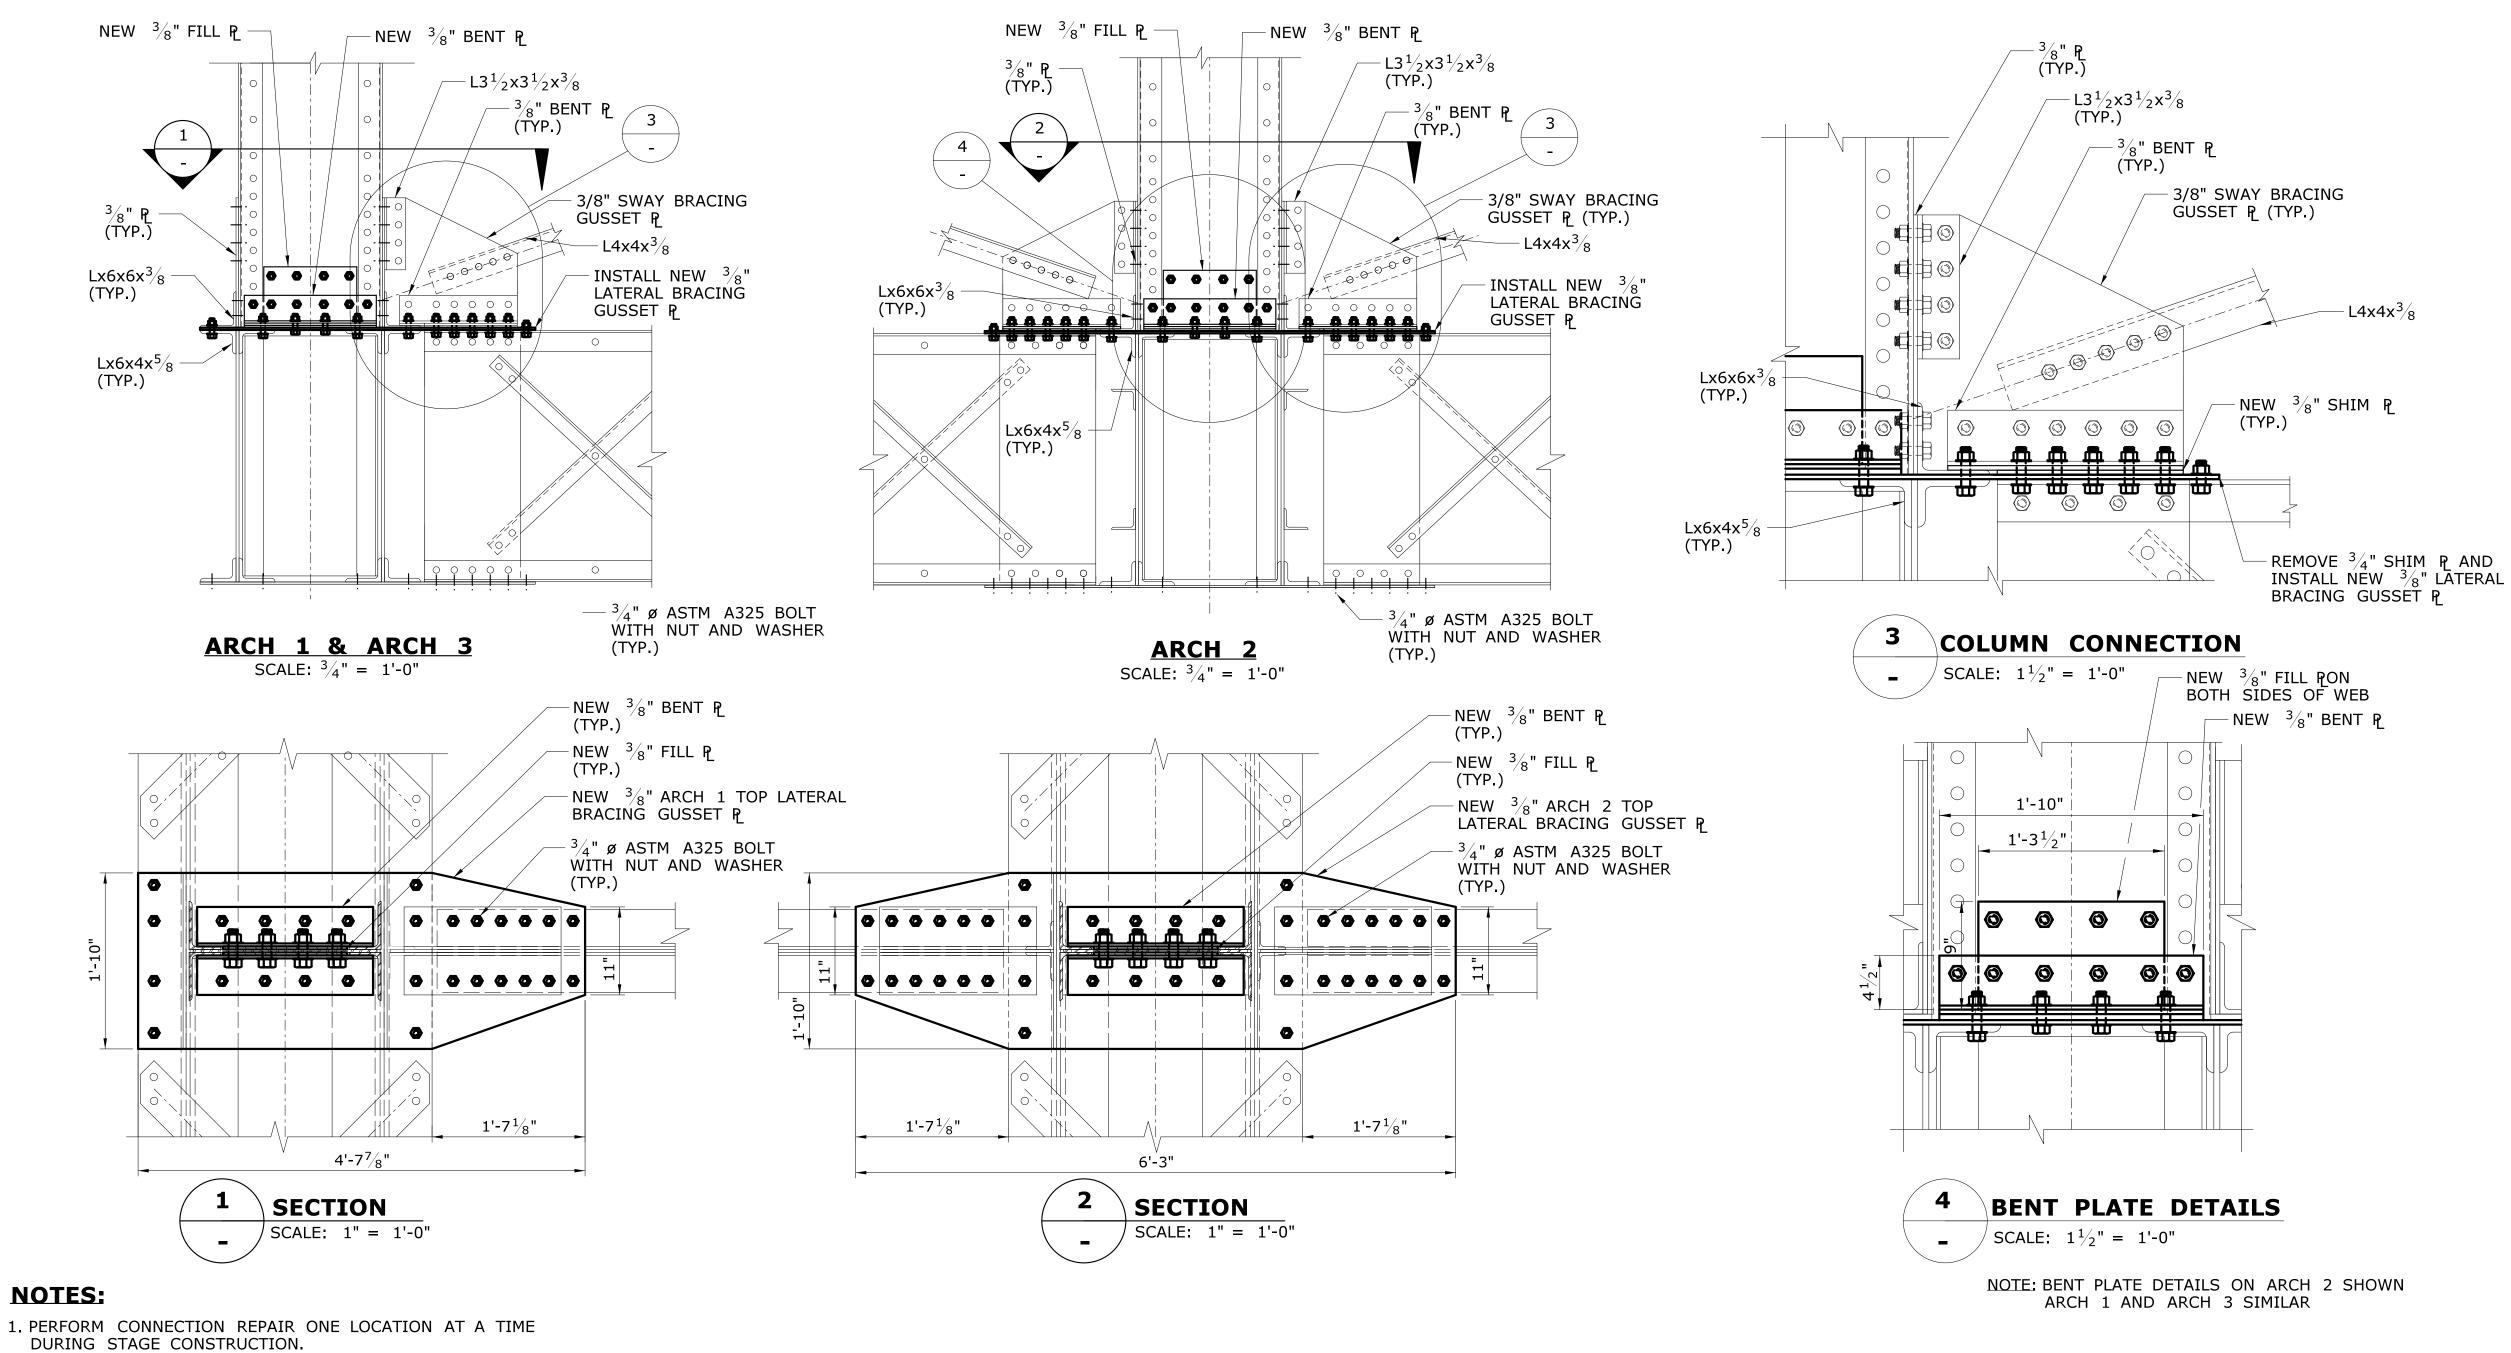REV. DATE

- 2. SUGGESTED SEQUENCE OF CONNECITON REPAIRS
- A. REMOVE EXISTING FASTENERS.
- B. JACK THE COLUMN AS SHOWN IN DWG S-31.
- C. REMOVE EXISTING BENT PLATES AND FILL PLATES. D. REMOVE EXISTING SHIMS AND GUSSET PLATE.
- E. APPLY HRCSA PENETRANT/SEALER ON CONTACT SURFACES BETWEEN STEEL MEMBERS.
- F. PLACE  $\frac{3}{8}$ " SHIM PLATES AND  $\frac{3}{8}$ " GUSSET PLATE.

REVISION DESCRIPTION


- G. SANDWICH THE DETERIORATED COLUMN WEB WITH NEW  $\frac{3}{8}$ " PLATES
- ON BOTH SIDES OF THE COLUMN. H. PLACE THE NEW  $\frac{3}{8}$ " BENT PLATES AND INSTALL BOLTS.
- I. JACK DOWN THE COLUMN AND TIGHTEN HIGH STRENGTH BOLTS TO
- COMPLETE CONNECTION REPAIR. J. REMOVE JACKING ASSEMBLY.
- 3. ALTERNATE LOAD PATHS TO THE ARCH RIB SHALL BE PROVIDED FOR ALL BRACING MEMBERS THAT ARE DISCONNECTED DURING STRUCTURAL REPAIRS. THE ALTERNATE LOAD PATHS FOR THE BRACING SHALL BRACE THE ARCH RIB AS CLOSE AS PRACTICAL TO THE ORIGINAL BRACE ATTACHMENT LOCATION.



THE INFORMATION, INCLUDING ESTIMATED	DESIGNER/DRAFTER: SC/NRA
QUANTITIES OF WORK, SHOWN ON THESE SHEETS IS BASED ON LIMITED INVESTIGATIONS BY THE STATE AND IS IN NO WAY WARRANTED TO INDICATE	CHECKED BY: <b>JG</b>
THE CONDITIONS OF ACTUAL QUANTITIES OF WORK WHICH WILL BE REQUIRED.	
	SCALE AS NOTED


SHEET NO. Plotted Date: 7/6/2016

STATE OF CONNECTICUT **DEPARTMENT OF TRANSPORTATION** Filename: ...\SB\_MSH\_158-207\_GUSSET PLATE REPAIRS (2 OF 2).dgn

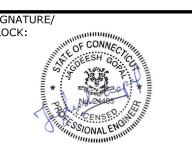

GM2 ASSOCIATES, INC. GLASTONBURY, CT 06033 REHABILITATION OF BRIDGE 00728 **MERRITT PARKWAY OVER SAUGATUCK RIVER** 

WESTPORT	158-207
DRAWING TITLE:	DRAWING NO. <b>S-32</b>
CONNECTION REPAIRS (2 OF 2)	SHEET NO. <b>05.03.32</b>

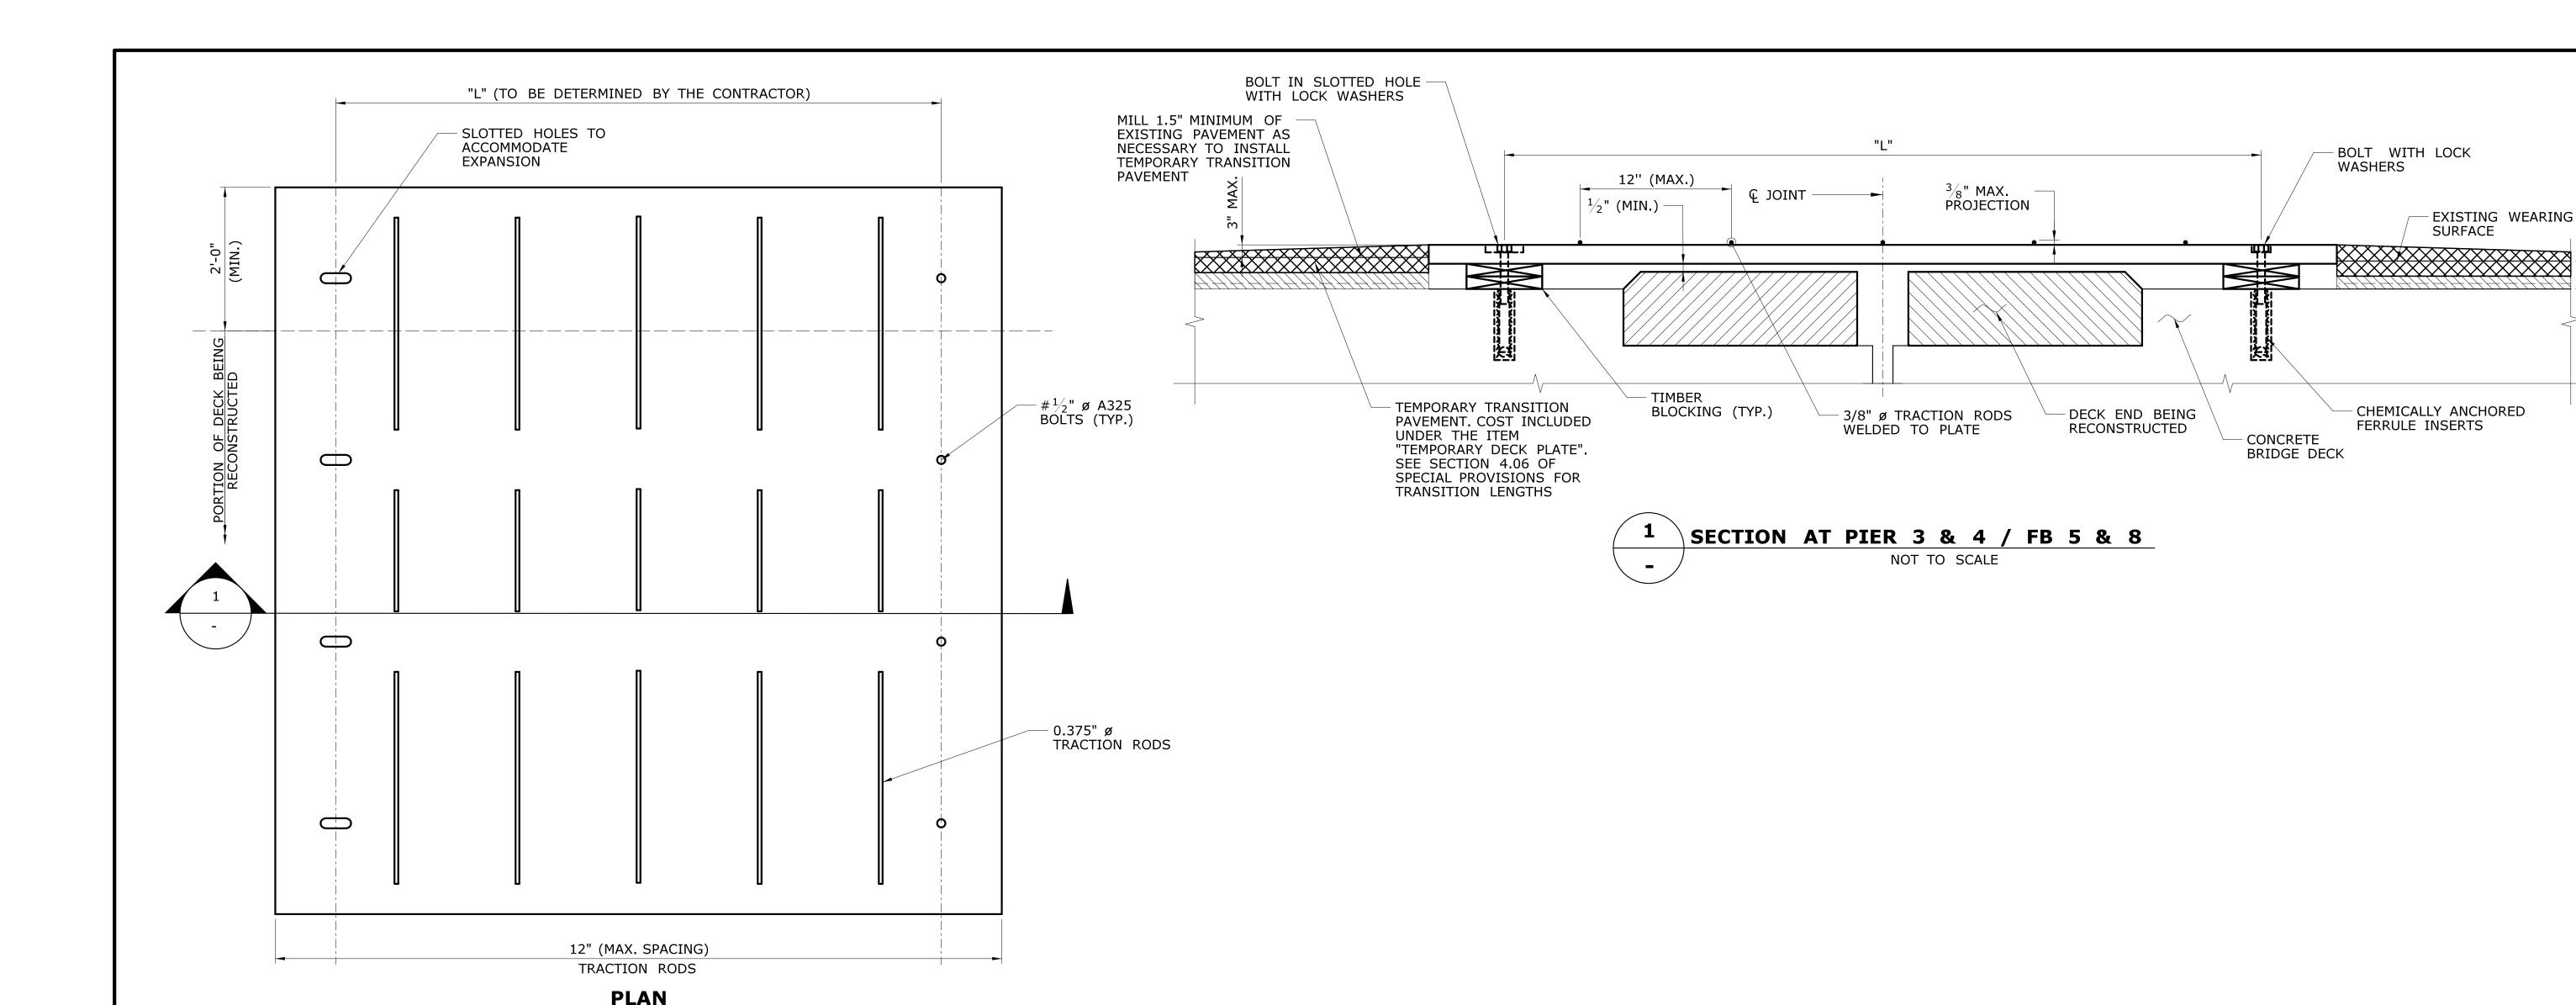

#### **TEMPORARY BRIDGING PLATE NOTES**

- 1. LONG DURATION STAGED CONSTRUCTION IS NOT ALLOWED. CONSTRUCTION OF JOINTS SHALL OCCUR DURING OFF-PEAK HOURS. THE ROADWAY SHALL BE OPENED TO TRAFFIC DURING PEAK HOURS IN ACCORDANCE WITH THE SPECIAL PROVISION "PROSECUTION AND PROGRESS".
- 2. A SUGGESTED DETAIL FOR THE TEMPORARY BRIDGING PLATE IS SHOWN ON THIS SHEET. THE CONTRACTOR SHALL DESIGN AND DETAIL A METHOD TO MAINTAIN TRAFFIC DURING PEAK HOURS USING A TEMPORARY REMOVABLE STEEL BRIDGING PLATE AND SUBMIT THE DESIGN AND CALCULATIONS FOR REVIEW. THE DESIGN SHALL BE STAMPED BY A PROFESSIONAL ENGINEER LICENSED IN THE STATE OF CONNECTICUT.
- 3. THE TEMPORARY STEEL BRIDGING PLATE SHALL BE PAID FOR UNDER THE ITEM "TEMPORARY DECK PLATE". THIS ITEM INCLUDES THE COST OF ALL NECESSARY WORK REQUIRED TO INSTALL, MAINTAIN AND REMOVE THE TEMPORARY BRIDGING PLATE.
- 4. THE DESIGN SHOULD SATISFY THE FOLLOWING CONDITIONS AT A MINIMUM:
  A. THE PLATE SHOULD BE REMOVABLE AND RE-INSTALLABLE.
  - B. LOCK-WASHERS OR OTHER MEANS SHOULD BE USED TO PREVENT THE BOLTS FROM COMING LOOSE DUE TO THE DYNAMIC EFFECTS OF VEHICULAR TRAFFIC
  - C. THE PLATE SHOULD BE ABLE TO ACCOMMODATE THE ANTICIPATED THERMAL MOVEMENT THAT IS LIKELY TO OCCUR DURING CONSTRUCTION.
  - D. NO PORTION OF THE PLATE SHOULD PROJECT MORE THAN  $\frac{3}{8}$ " FROM THE TOP OF THE RIDING SURFACE E. THE DEFLECTION OF THE PLATE SHOULD NOT EXCEED "L/400". WHERE "L" IS THE SPAN LENGTH BETWEEN SUPPORTS.
- E. THE DEFLECTION OF THE PLATE SHOULD NOT EXCEED "L/400". WHERE "L" IS THE SPAN LENGTH BETWEEN SUPPORTS.


  F. A MINIMUM OF  $\frac{1}{2}$ " SHALL BE MAINTAINED BETWEEN THE TOP OF DECK/HEADERS AND THE BOTTOM OF THE STEEL PLATE AT ALL TIMES.


NOT TO SCALE


- G. IN THE EVENT THAT THE TOP OF THE PLATE WILL PROJECT ABOVE THE RIDING SURFACE, TAPERED TEMPORARY PAVEMENT WILL BE REQUIRED TO ALLOW FOR A SMOOTH TRANSITION FOR TRAFFIC AND AVOID A "BUMP" IN THE ROADWAY.
- H. A MINIMUM OF 2'-0" (PERPENDICULAR TO TRAFFIC) SHALL BE MAINTAINED FROM THE EDGE OF THE TEMPORARY PLATE TO THE NEAREST EDGE OF LANE CARRYING TRAFFIC.
- I. TRANSITIONS/WEDGE PAVEMENT IN APPROACHES SHALL BE AS NOTED IN SECTION 4.06. SEE SPECIAL PROVISIONS. TRANSITIONS/WEDGE PAVEMENT SHALL BE
- PROVIDED IN BOTH DIRECTIONS (PARALLEL AND PERPENDICULAR TO TRAFFIC).


  J. HEIGHT FROM THE TOP THE TEMPORARY STEEL PLATE TO THE ORIGINAL RIDING SURFACE SHALL NOT EXCEED 3".
- K. THE MINIMUM PLATE WIDTH TRANSVERSE TO TRAFFIC SHALL BE 4'-0".
- L. THE PLATES SHALL BE DESIGNED FOR A 32 KIP WHEEL LOAD.
- 5. SEE SPECIAL PROVISION "TEMPORARY DECK PLATE" FOR ADDITIONAL REQUIREMENTS.
- 6. THE DETAIL FOR THE TEMPORARY DECK PLATE SHOULD BE ABLE TO ACCOMMODATE CROSS-SLOPES ON THE BRIDGE AND BE ABLE TO ACCOMMODATE ANCHOR INSTALLATION TOLERANCES IN BOTH LONGITUDINAL AND TRANSVERSE DIRECTIONS.
- 7. TEMPORARY DECK PLATES WILL NOT BE APPROVED FOR USE IN JOINTS WHERE DECK RECONSTRUCTION IS NOT REQUIRED.

THE INFORMATION, INCLUDING ESTIMATED QUANTITIES OF WORK, SHOWN ON THESE CH	ESIGNER/DRAFTER:  GP  HECKED BY:	CONNECTICITY OF THE PROPERTY O	SIGNATURE/ GM2 BLOCK: 115 GLAS	2 ASSOCIATES, INC. GLASTONBURY BLVD. STONBURY, CT 06033  PROJECT TITLE:  REHABILITATION OF BI	RIDGE 00728		PROJECT NO. <b>158-207</b>
SHEETS IS BASED ON LIMITED INVESTIGATIONS BY THE STATE AND IS IN NO WAY WARRANTED TO INDICATE THE CONDITIONS OF ACTUAL QUANTITIES	JG	DEPARTMENT OF TRANSPORTATION	The second of th	MERRITT PARKV		DIVITING TITLE!	DRAWING NO.  S-33
OF WORK WHICH WILL BE REQUIRED.	SCALE AS NOTED	DEPARTMENT OF TRANSPORTATION	SONAL ENGRICHMENT	OVER SAUGATUCK	RIVER	SUGGESTED TEMPORARY PLATE DETAIL	SHEET NO. <b>05.03.33</b>
REV. DATE REVISION DESCRIPTION SHEET NO. Plotted Date: 7/6/2016		Filename:\SB_MSH_158-207_PLATE_DTLdgn	A Million			I LAIL DLIAIL	

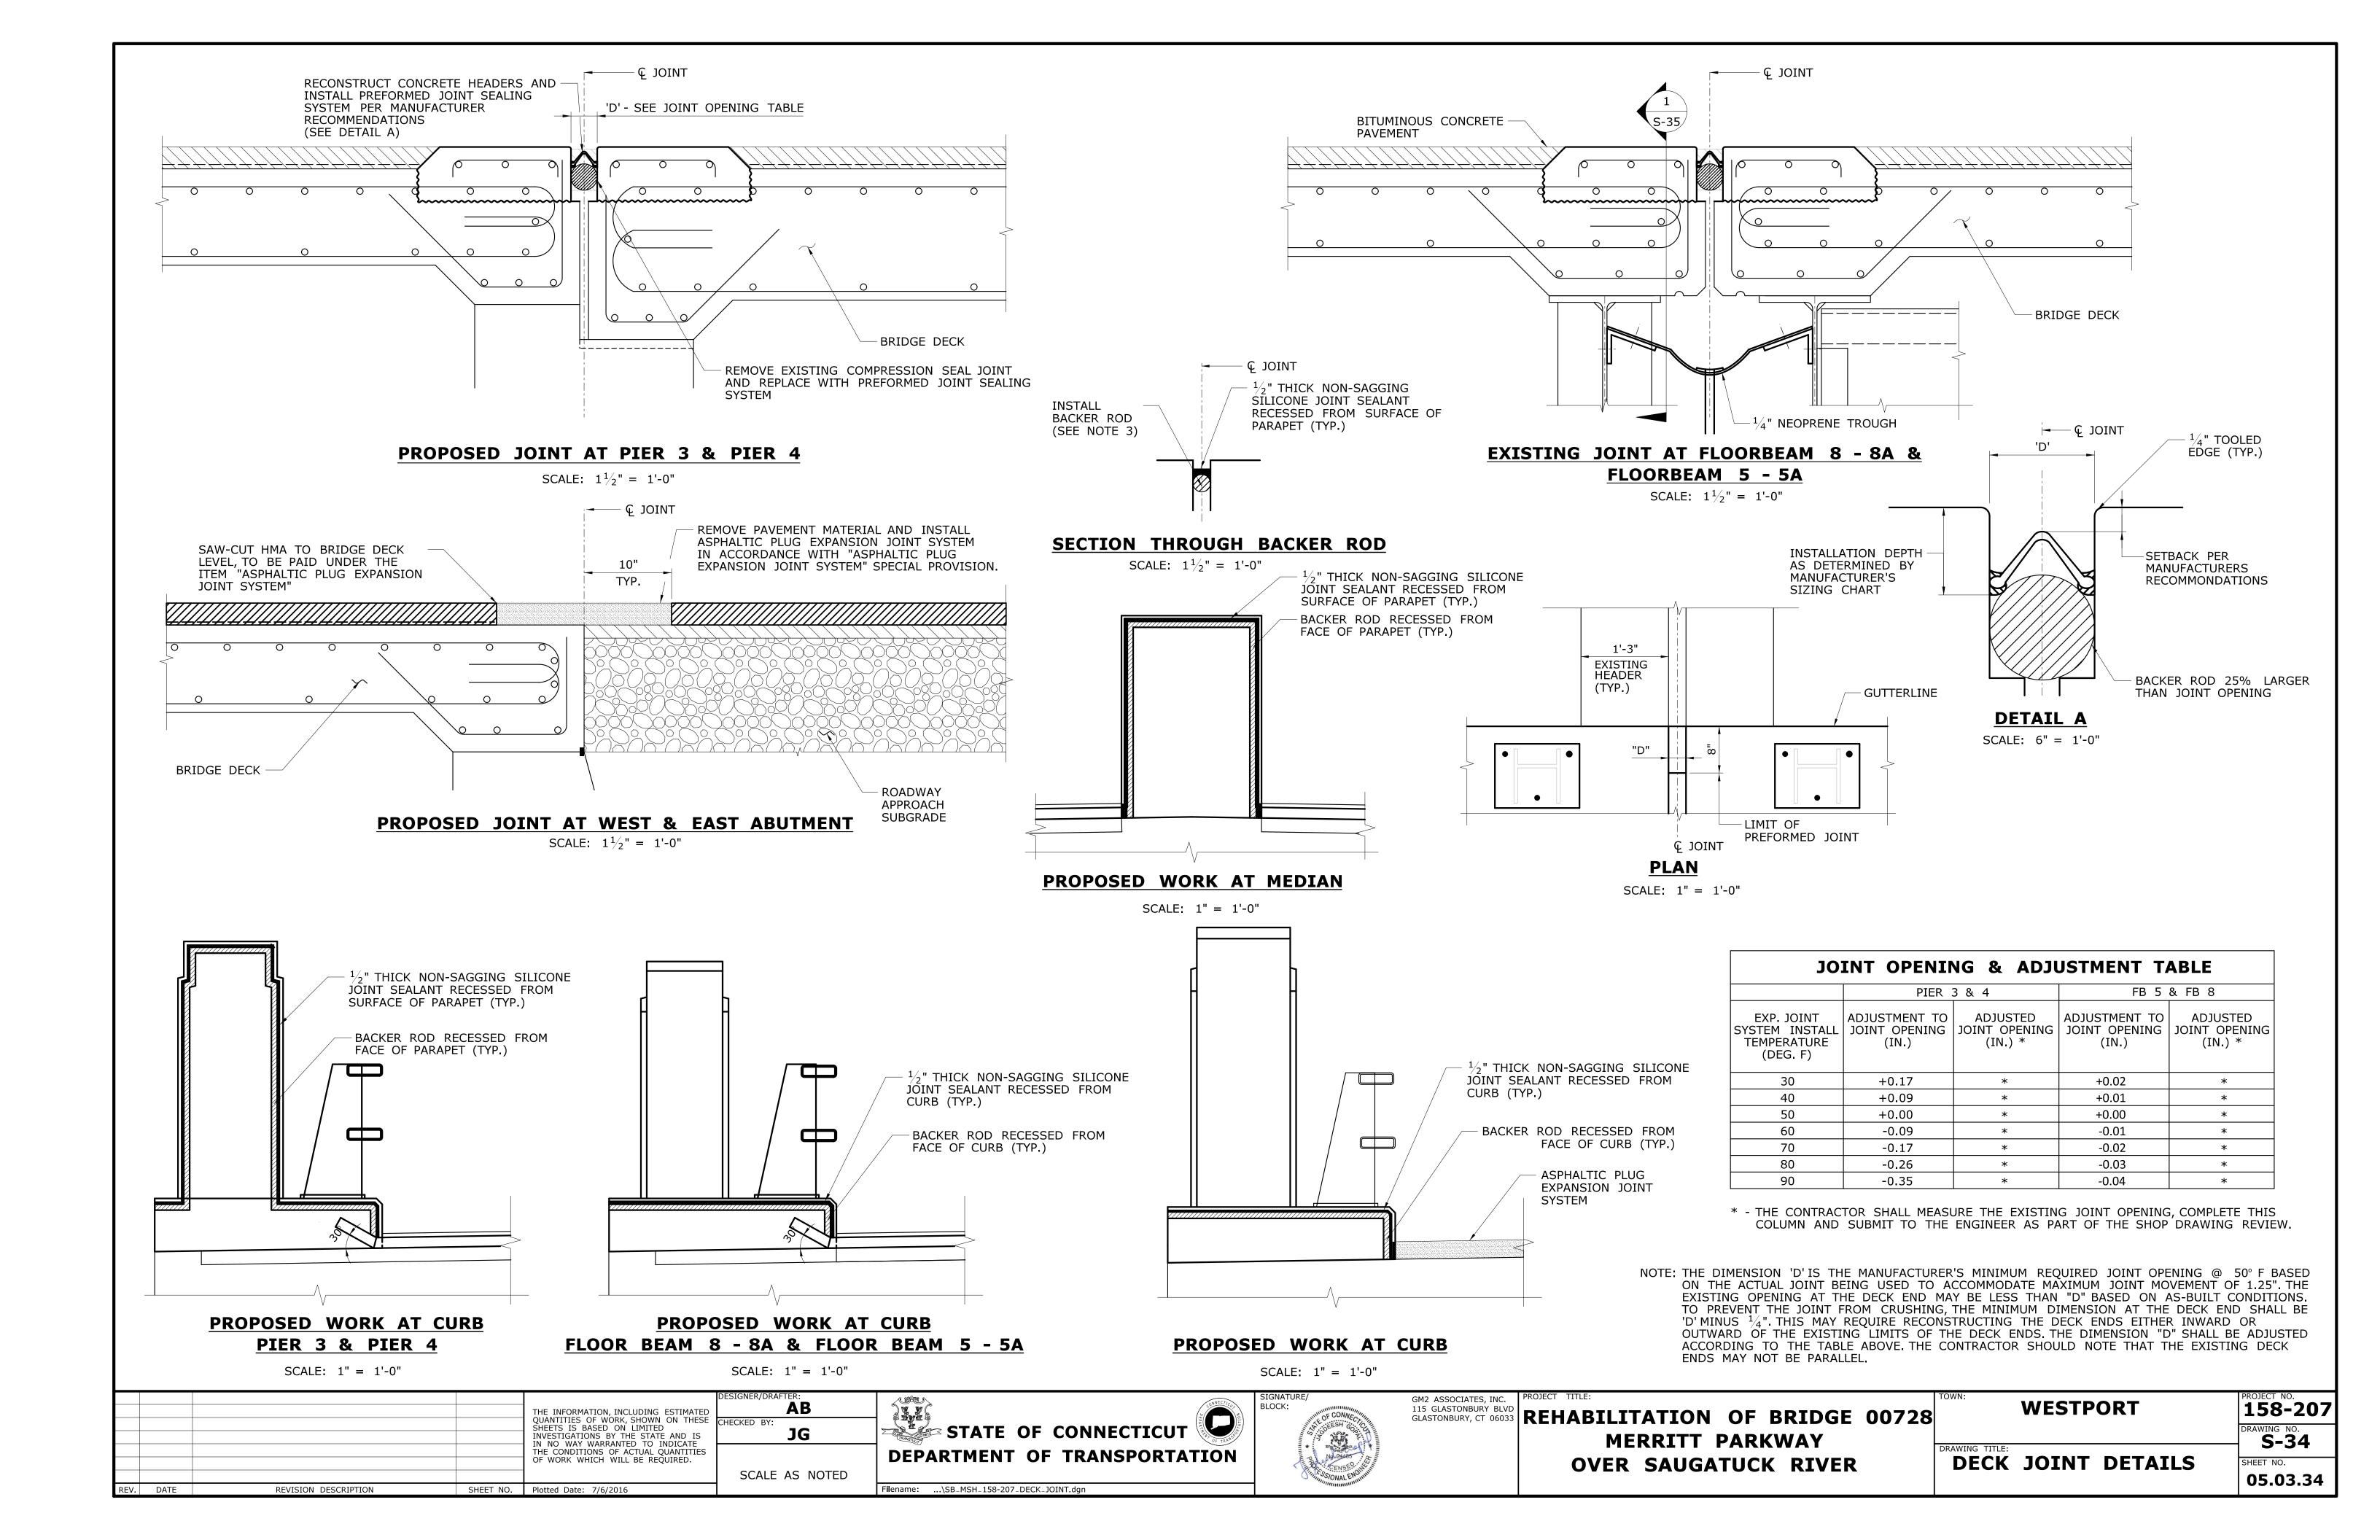

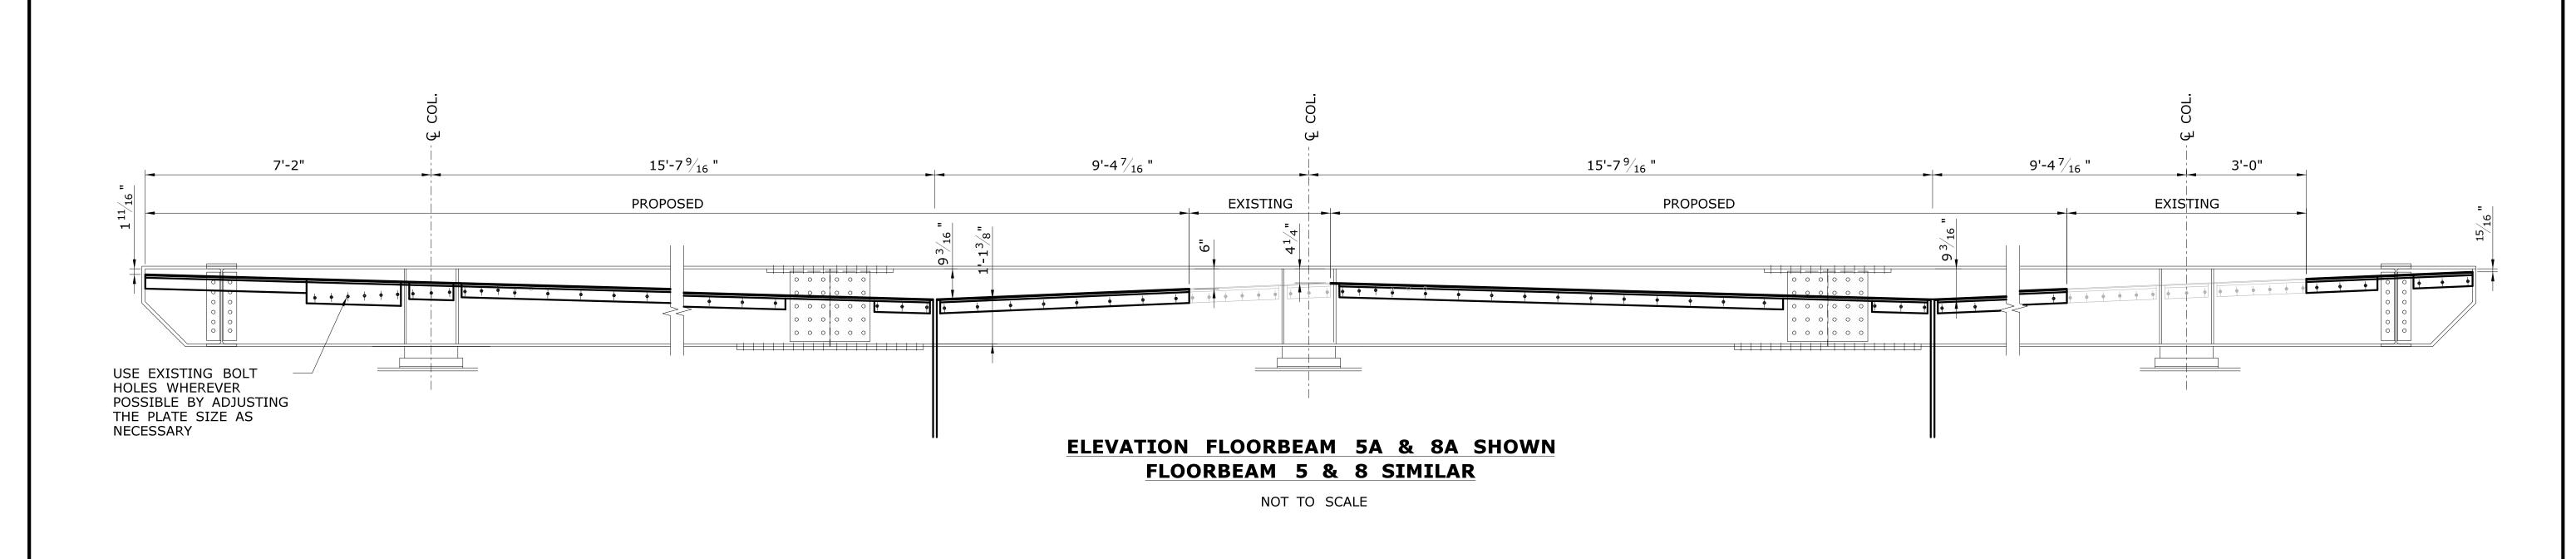

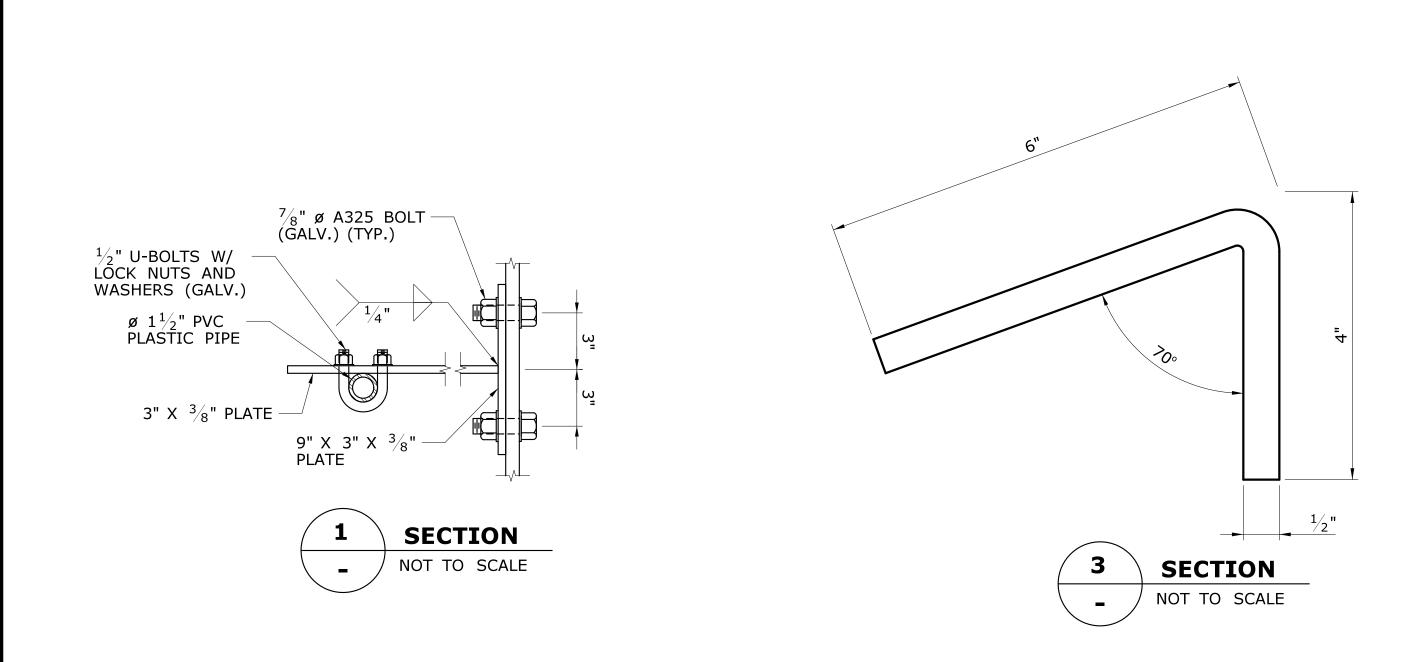

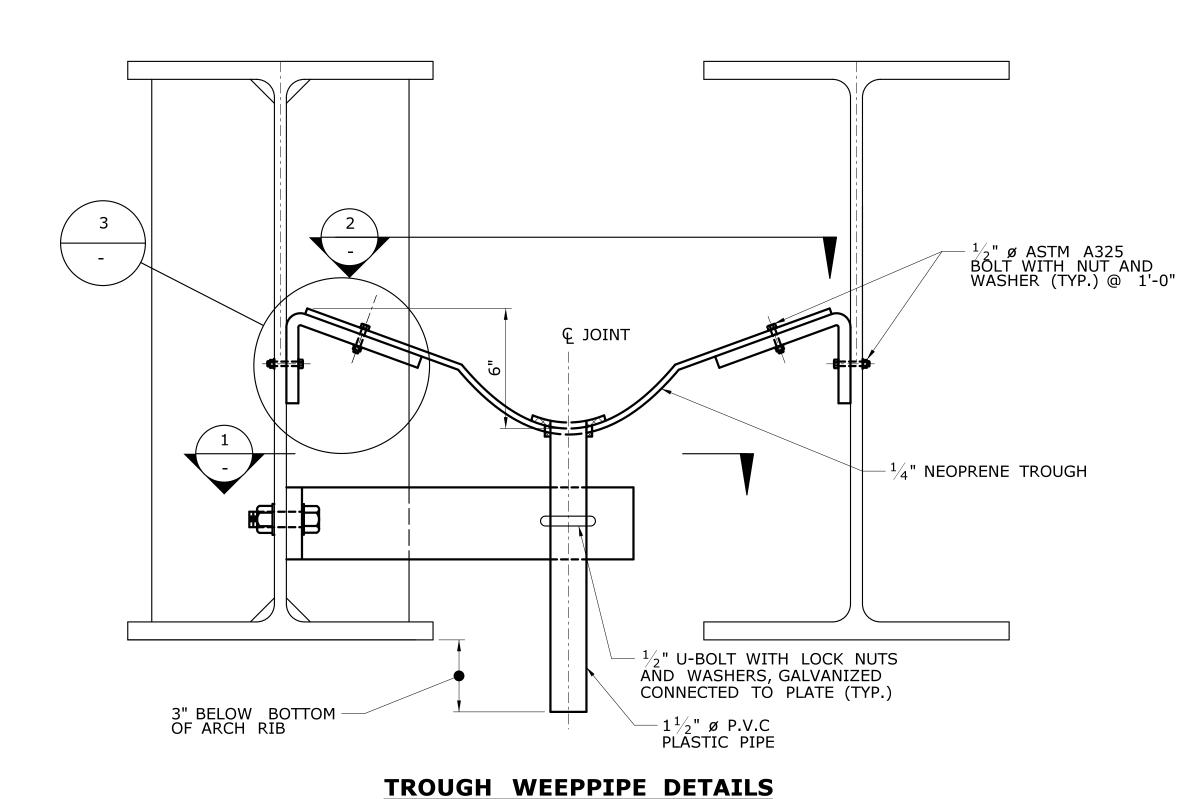


#### **NOTES:**


 INSTALLATION OF BENT PLATES, TROUGH, WEEP PIPES, ANCHORAGE AND ALL NECESSARY ITEMS, TO BE PAID UNDER ITEM "REHABILITATION OF EXISTING STRUCTURAL STEEL".

NOT TO SCALE


2. WEEPPIPE SHALL BE CONNECTED TO THE TROUGH USING RUBBER AND SHALL BE ATTACHED USING GLUE.


SHEETS IS ASSED ON LIMITED INVESTIGATIONS BY THE STATE AND IS IN NO WAY WARRANTED TO INDICATE THE CONDITIONS OF ACTUAL QUANTITIES OF WORK WHICH WILL BE REQUIRED.  SHEETS IS ASSED ON LIMITED INVESTIGATIONS OF MILE STATE AND IS IN NO WAY WARRANTED TO INDICATE THE CONDITIONS OF ACTUAL QUANTITIES OF WORK WHICH WILL BE REQUIRED.  DEPARTMENT OF TRANSPORTATION  OVER SAUGATUCK RIVER  TROUGH DETAILS	THE INFORMATION, INCLUDING ESTIMATED QUANTITIES OF WORK, SHOWN ON THESE CHECKED, BY:	SIGNATURE/ BLOCK:  REHABILITATION OF BRID	OGE 00728 TOWN: WESTPORT 158-207
OVER SAUGATUCK RIVER TROUGH DETAILS	IN NO WAY WARRANTED TO INDICATE		DRAWING TITLE:  DRAWING TITLE:  DRAWING NO.  S-35
SCALE AS NOTED	OF WORK WHICH WILL BE REQUIRED.  SCALE AS NOTED	OVER SAUGATUCK RI	VER TROUGH DETAILS  SHEET NO.  05.03.35

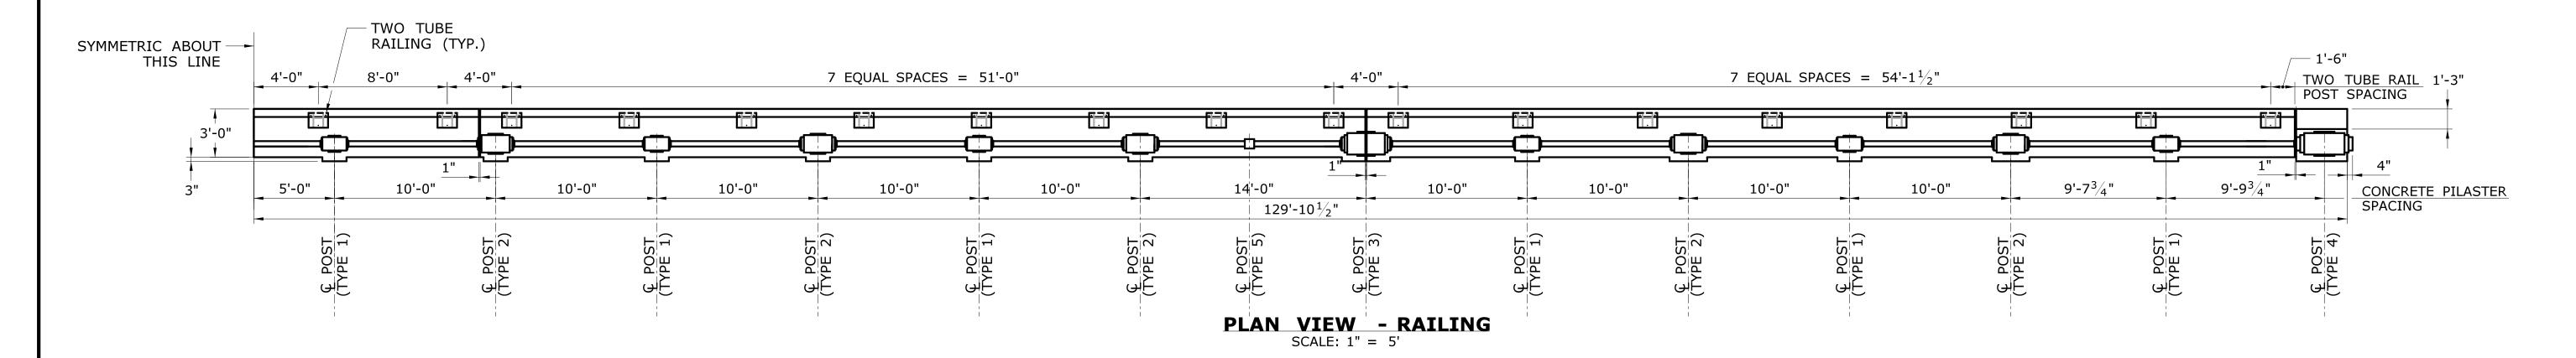

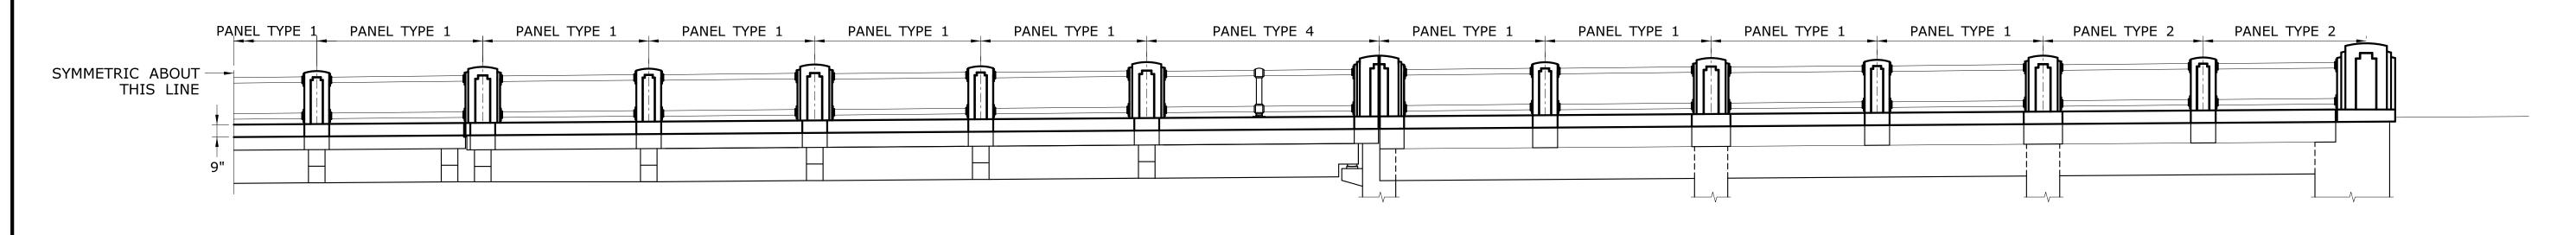

ELEVATION SCALE: 1" = 5'

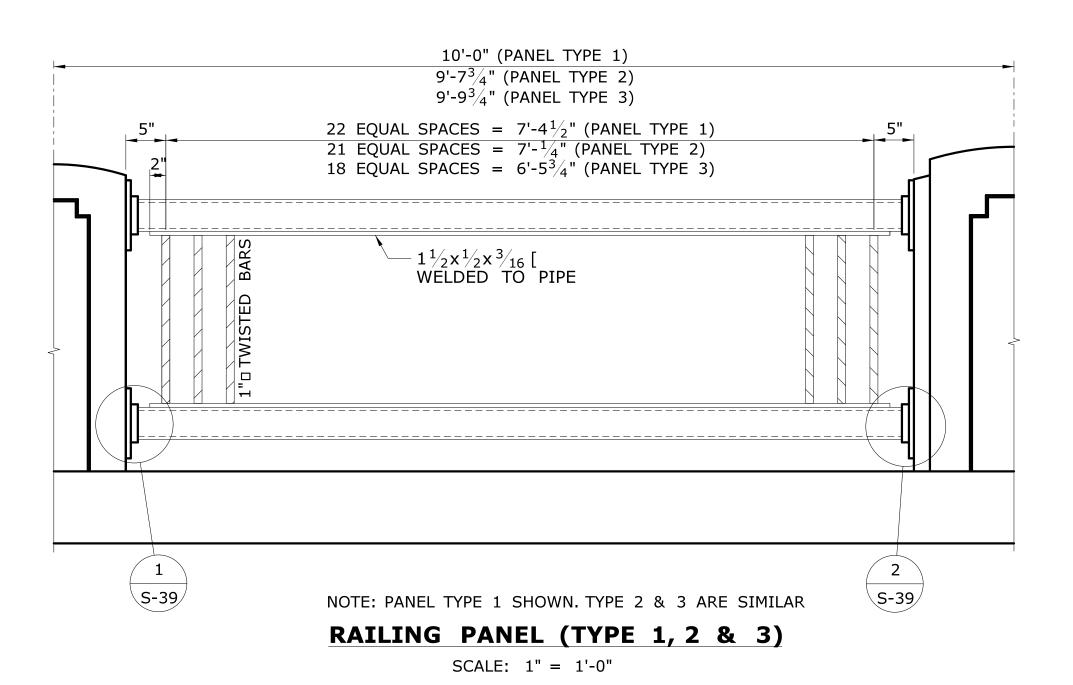

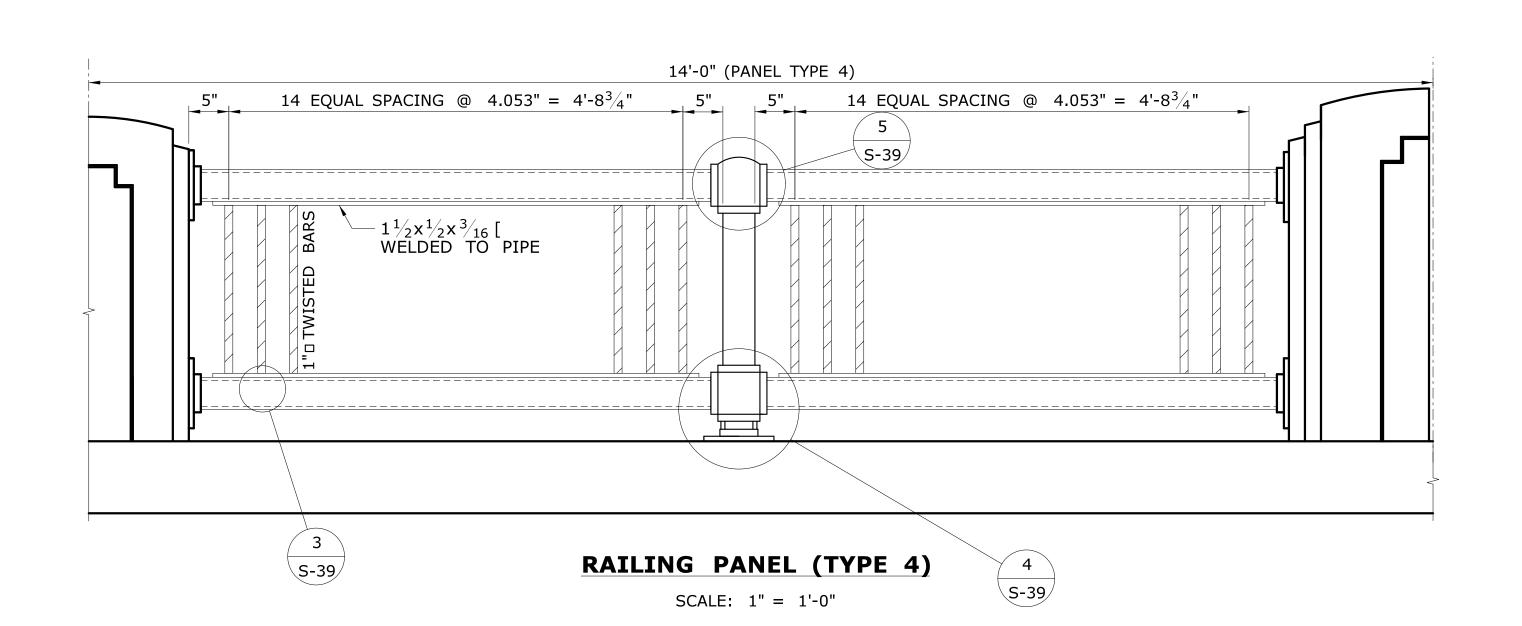

#### **NOTES:**

- 1. ALL RAIL ELEMENTS SHALL BE PAINTED USING HRCSA CORROSION PROTECTION SYSTEM IN ACCORDANCE WITH ITEM "HRCSA CORROSION PROTECTION SYSTEM" BUT SHALL BE PAID UNDER ITEM "METAL BRIDGE RAIL (ORNAMENTAL GRILLE)".
- 2. CONCRETE FOR ORNAMENTAL POSTS SHALL BE IN ACCORDANCE WITH CLASS "C" CONCRETE REPLICATED SPECIAL PROVISION AND SHALL BE PAID UNDER ITEM "CLASS "C" CONCRETE REPLICATED".
- 3. STEEL RAILING ELEMENTS SHALL BE PAID UNDER ITEM "METAL BRIDGE RAIL (ORNAMENTAL GRILLE)" AND IN ACCORDANCE WITH SPECIAL PROVISION.

		THE INFORMATION, INCLUDING ESTIMATED	DESIGNER/DRAFTER:  NRA	CONNECTICAL S	SIGNATURE/ BLOCK:	GM2 ASSOCIATES, INC. PROJECT TITLE: 115 GLASTONBURY BLVD. GLASTONBURY, CT 06033	WESTPORT	PROJECT NO. <b>158-207</b>
		QUANTITIES OF WORK, SHOWN ON THESE SHEETS IS BASED ON LIMITED INVESTIGATIONS BY THE STATE AND IS IN NO WAY WARRANTED TO INDICATE	CHECKED BY:  JG	STATE OF CONNECTICUT	THE SEESH CO.	REHABILITATION OF BRIDGE 00728 MERRITT PARKWAY	3	DRAWING NO.  S-36
		THE CONDITIONS OF ACTUAL QUANTITIES OF WORK WHICH WILL BE REQUIRED.		DEPARTMENT OF TRANSPORTATION	NA 2405	OVER SAUGATUCK RIVER	BRIDGE RAILING	SHEET NO.
			SCALE AS NOTED		STATES SONAL ENGINEER		DETAILS (1 OF 4)	05.03.36
REV. DATE REVISION DESCRIPTION	SHEET NO.	Plotted Date: 7/6/2016		Filename:\SB_MSH_158-207_RAILING_DTL_1.dgn	- Annamin		DETAILS (I OI 4)	33.03.30

